
VIRGINIA'S FARMHOUSE

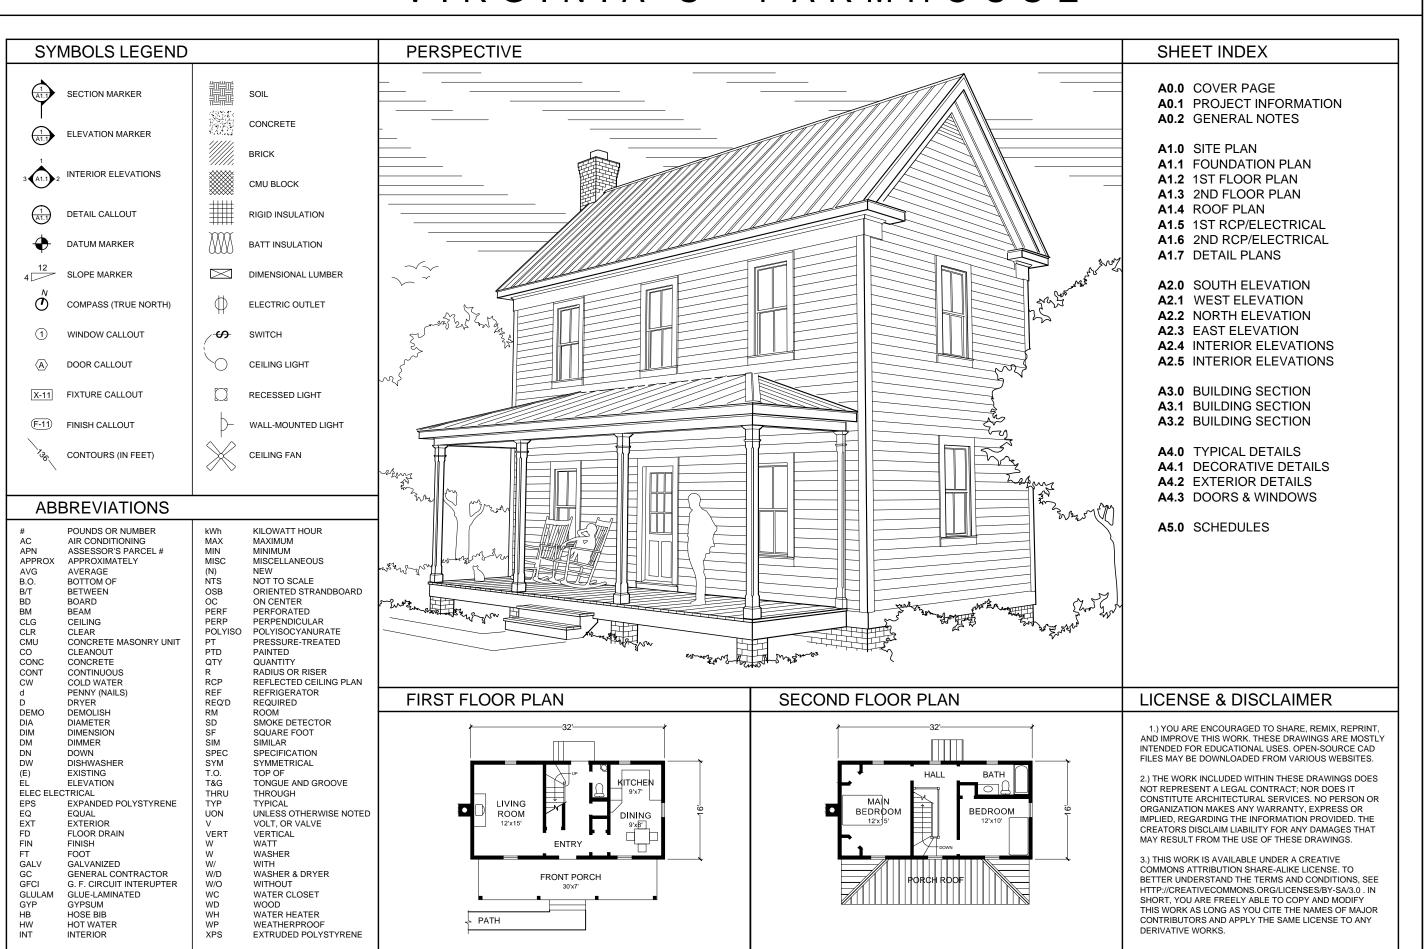



OPEN-SOURCE BLUEPRINTS

CAD FILES AVAILABLE www.amatect.com/farmhouse www.commons.wikimedia.org /wiki/File:FarmhouseV-001.svg openarchitecturenetwork.org / projects/farmhouse

ORIGINAL DESIGNER Jay Osborne, 2014

> Ш S ഗ Z ≥ 0 0 工 \vdash ⋝ \supset 0 > ⋖ ш α $\mathbf{\times}$ ഗ \circ α ≥ 0 Δ က

REVISION

\triangle	VERSION 0.01 02-15-2015
\triangle	

 \triangle

7

DATE


02-15-15

SHEET TITLE

COVER PAGE

SHEET NO

A0.0

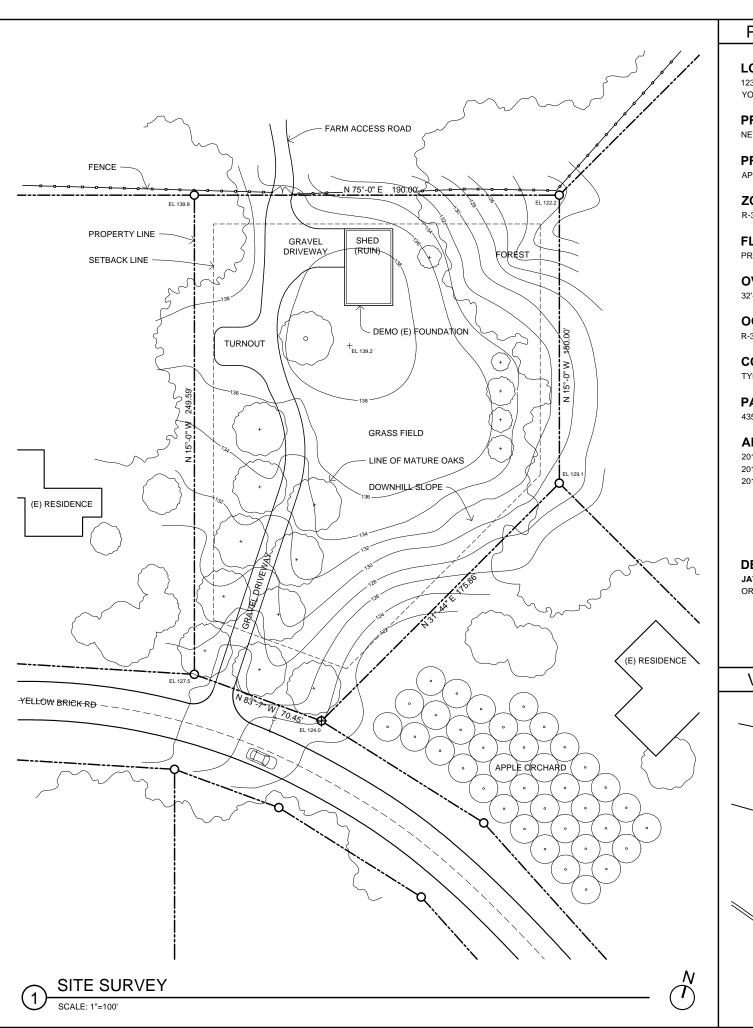

PROJECT INFORMATION

LOCATION

123 YELLOW BRICK RD YOURTOWN, US 12345

PROJECT DESCRIPTION

NEW SINGLE-FAMILY HOUSE

PROJECT NUMBER

APN 0000-0000-000-000

ZONING

FLOOR AREA

PROPOSED: 975 FT²

OVERALL BUILDING HEIGHT

32'-0" - GROUND TO ROOF RIDGE

OCCUPANCY

R-3, 1-4 PEOPLE

CONSTRUCTION TYPE

TYPE V - WOOD FRAME CONSTRUCTION

PARCEL SIZE

43560 S.F. (1.00 ACRES)

APPLICABLE CODES

2014 STATE BUILDING CODE 2014 STATE ELECTRICAL CODE 2012 LOCAL FIRE CODE


DESIGN CONTRIBUTORS

JAY OSBORNE, 2014-15

ORIGINAL DESIGN, CAD FILE TEMPLATE, CONSTRUCTION DRAWING SET

VICINITY MAP

(NOT TO SCALE)

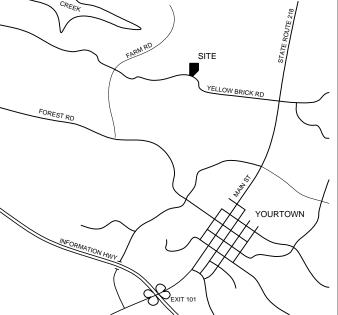

OWNER

VIRGINIA WOOLF PHONE NUMBER EMAIL ADDRESS NOTES

ARCHITECT OF RECORD

CONTACT INFORMATION

CONTACT PERSON COMPANY NAME PHONE NUMBER STREET ADDRESS EMAIL ADDRESS CITY / STATE / ZIP NOTES

GENERAL CONTRACTOR

CONTACT PERSON COMPANY NAME PHONE NUMBER STREET ADDRESS EMAIL ADDRESS CITY / STATE / ZIP NOTES

STRUCTURAL CONSULTANT

CONTACT PERSON COMPANY NAME PHONE NUMBER STREET ADDRESS EMAIL ADDRESS CITY / STATE / ZIP NOTES

LANDSCAPE CONTRACTOR

CONTACT PERSON COMPANY NAME PHONE NUMBER STREET ADDRESS EMAIL ADDRESS CITY / STATE / ZIP NOTES

PLUMBING CONTRACTOR

CONTACT PERSON COMPANY NAME PHONE NUMBER STREET ADDRESS EMAIL ADDRESS CITY / STATE / ZIP NOTES

ELECTRICAL CONTRACTOR

CONTACT PERSON COMPANY NAME PHONE NUMBER STREET ADDRESS EMAIL ADDRESS CITY / STATE / ZIP NOTES

HVAC CONTRACTOR

CONTACT PERSON COMPANY NAME PHONE NUMBER STREET ADDRESS EMAIL ADDRESS CITY / STATE / ZIP NOTES

PLOT SURVEYOR

CONTACT PERSON COMPANY NAME PHONE NUMBER STREET ADDRESS EMAIL ADDRESS CITY / STATE / ZIP NOTES

WOODSTOVE CONSULTANT

CONTACT PERSON COMPANY NAME PHONE NUMBER STREET ADDRESS EMAIL ADDRESS CITY / STATE / ZIP NOTES

BUILDING INSPECTOR

CONTACT PERSON COMPANY NAME PHONE NUMBER STREET ADDRESS EMAIL ADDRESS CITY / STATE / ZIP NOTES

OPEN-SOURCE BLUEPRINTS

CAD FILES AVAILABLE www.amatect.com/farmhouse www.commons.wikimedia.org /wiki/File:FarmhouseV-001.svg openarchitecturenetwork.org /projects/farmhouse

ORIGINAL DESIGNER Jay Osborne, 2014

> Ш S ഗ Z ≥ O 0 工 ď ⋝ \supset 0 \succ ⋖ Ω ш \propto $\mathbf{\times}$ \circ \propto Ω ≥ 0 Ш \succ 33

REVISION

VERSION 0.01 02-15-2015

 \triangle

DATE

02-15-15

SHEET TITLE

PROJECT INFORMATION

SHEET NO.

GENERAL NOTES

- 1. WORK SHALL CONFORM TO ALL APPLICABLE CODES AND ORDINANCES, INCLUDING BUT NOT LIMITED TO: BUILDING, PLUMBING, ELECTRICAL, AND MECHANICAL CODES.
- 2. ANY ERRORS, OMISSIONS, OR CONFLICTS FOUND WITHIN THESE DRAWINGS SHALL BE BROUGHT TO THE ATTENTION OF THE OWNER OR THEIR REPRESENTATIVE REFORE PROCEEDING WITH THE WORK
- 3. DO NOT SCALE THESE DRAWINGS. WRITTEN DIMENSIONS TAKE PRECEDENCE OVER MEASUREMENTS.
- 4. DIMENSIONS ARE TAKEN FROM FACE OF FRAMING LUMBER, FACE OF CONCRETE/ MASONRY, CENTER OF COLUMN, AND CENTERLINE OF FIXTURE, UNLESS NOTED OTHERWISE.
- 5. ALL DIMENSIONS NOTED "VERIFY IN FIELD (V.I.F.)" SHALL BE MEASURED BY THE CONTRACTOR PRIOR TO CONSTRUCTION. REPORT ANY DISCREPANCIES TO THE OWNER OR THEIR REPRESENTATIVE.
- 6. DETAILS SHOWN ARE TYPICAL. SIMILAR DETAILS APPLY IN SIMILAR SITUATIONS
- 7. IN THE CASE OF DISCREPANCIES WITHIN DESCRIPTIONS OF SIMILAR ITEMS, PRECEDENCE SHALL BE GIVEN TO NOTES & DRAWINGS OF GREATER DETAIL.
- 8. ALL REQUIRED EXITS SHALL BE OPERABLE FROM THE INSIDE, WITHOUT THE USE OF A KEY OR ANY SPECIAL KNOWLEDGE.
- 9. ANY ELECTRICAL, PLUMBING AND/OR HVAC SYSTEMS INCLUDED IN THE WORK SHALL BE INSTALLED ON A DESIGN-BUILD BASIS, AND SHALL NOT SIGNIFICANTLY ALTER THE STRUCTURE OR FINISHES.

CONSTRUCTION NOTES

- 1. ALL CONSTRUCTION SHALL BE TRUE, PLUMB, LEVEL, SQUARE, AND IN PROPER ALIGNMENT.
- 2. THE GENERAL CONTRACTOR SHALL MAINTAIN A CURRENT AND COMPLETE SET OF DRAWINGS ON THE JOB SITE DURING ALL PHASES OF CONSTRUCTION. ALL SUBCONTRACTORS SHALL BE PROVIDED WITH A SET OF DRAWINGS.
- 3. THE GENERAL CONTRACTOR SHALL VERIFY AND ASSUME RESPONSIBILITY FOR ALL DIMENSIONS AND SITE CONDITIONS, AS WELL AS INSPECT THE PREMISES AND TAKE NOTE OF EXISTING CONDITIONS PRIOR TO SUBMITTING PRICES. NO CLAIM SHALL BE ALLOWED FOR PROBLEMS WHICH COULD HAVE BEEN REASONABLY PREVENTED BY A THOROUGH EXAMINATION.
- 4. PROVIDE TEMPORARY SUPPORT AS NECESSARY TO ENSURE THE STRUCTURAL INTEGRITY OF THE BUILDING UNDER CONSTRUCTION. THE GENERAL CONTRACTOR IS RESPONSIBLE FOR ALL CONSTRUCTION-RELATED ACTIVITIES.
- 5. INSTALL FIXTURES, MATERIALS, AND EQUIPMENT ACCORDING TO MANUFACTURERS SPECIFICATIONS. SHOULD THOSE SPECS CONFLICT WITH THE DRAWINGS, IMMEDIATELY NOTIFY THE OWNER OR THE OWNER'S REPRESENTATIVE.
- 6. VERIFY CLEARANCES FOR FIXTURES, VENTS, CHASES, ETC. BEFORE ORDERING OR INSTALLING RELATED WORK ITEMS.
- 7. INSTALL SMOKE DETECTORS AND FIRE EXTINGUISHERS IN CONFORMANCE TO LOCAL FIRE MARSHALL REQUIREMENTS.
- 8. ALL REQUIRED EXITS SHALL BE OPERABLE FROM THE INSIDE, WITHOUT THE USE OF A KEY OR ANY SPECIAL KNOWLEDGE.
- 9. COORDINATE ALL WORK WITH EXISTING CONDITIONS, INCLUDING BUT NOT LIMITED TO: IRRIGATION PIPES, ELECTRICAL CONDUITS, WATER LINES, GAS LINES. AND DRAINAGE LINES.
- 10. THE GENERAL CONTRACTOR SHALL BE RESPONSIBLE FOR REGULARLY REMOVING THE WASTE MATERIALS OF ALL SUBCONTRACTORS, AND MAINTAIN STRICT CONTROL OVER JOB CLEANING TO PREVENT DUST AND RUBBISH FROM INTERFERING WITH OPERATIONS.
- 11. CONSTRUCTION EQUIPMENT NOISE SHALL BE MINIMIZED DURING THE CONSTRUCTION PHASES BY MUFFLING AND SHIELDING IMPACT TOOLS WHENEVER POSSIBLE.

SITEWORK / GRADING NOTES

- 1. GRADING AND SITEWORK TO BE MINIMAL IN ALL AREAS NOT DIRECTLY AFFECTED BY THE NEW CONSTRUCTION. FOLLOW BEST PRACTICES AND LOCAL REQUIREMENTS IN ORDER TO MINIMIZE ENVIRONMENTAL DAMAGE.
- 2. PLUMBING LINES AND SEPTIC SYSTEMS ARE TO BE INSTALLED ON A DESIGN-BUILD BASIS, DEPENDENT ON VARIOUS SITE CONDITIONS. CONSULT A SOILS ENGINEER TO DETERMINE SUITABILITY FOR SPECIFIC INSTALLATIONS.
- 3. FINISH GRADE MUST SLOPE AWAY FROM EXTERIOR FOUNDATION WALL, AT A HEIGHT OF 6 INCHES OVER A 10 FOOT DISTANCE.
- 4. ANY SURVEY MARKERS WITHIN THE AREA OF CONSTRUCTION SHALL BE PRESERVED OR RESET BY A REGISTERED CIVIL ENGINEER OR LICENSED LAND SURVEYOR.
- 5. BEFORE GRADING OPERATIONS, A TEMPORARY PROTECTION FENCE SHALL BE CONSTRUCTED AROUND ANY TREE WITHIN 30 FEET OF THE FOUNDATION, AND A SILT FENCE MUST BE CONSTRUCTED DOWNSLOPE OF ANY AREA WHERE THE SOIL IS DISTURBED.

FOUNDATION NOTES

- DIFFERENT CLIMATES AND SOIL CONDITIONS REQUIRE DIFFERENT DESIGNS FOR A FOUNDATION. THE DEPICTED FOUNDATION SHOWS ONLY A PROPOSED DESIGN BASED ON FICTIONAL CONDITIONS. CONSULT A SOILS ENGINEER AND STRUCTURAL ENGINEER WHEN DESIGNING A FOUNDATION FOR YOUR SITE.
- 2. FOOTINGS SHALL EXTEND DOWN BEYOND THE LOCAL FROST LINE.
- 3. CMU/BRICK STEM WALL MUST BE REINFORCED WITH STEEL. PROVIDE CONCRETE REINFORCEMENT WITHIN FOUNDATION AS REQUIRED BY CODE.
- 4. PERFORATED DRAINAGE PIPES SHALL BE LOCATED WITHIN A GRAVEL PERIMETER AROUND THE FOUNDATION, AND INCORPORATE MULTIPLE DRAINAGE OUTLETS LEADING DOWNSLOPE AWAY FROM THE BUILDING.

FRAMING NOTES

- 1. PROVIDE TEMPORARY SUPPORT AS NECESSARY TO ENSURE THE STRUCTURAL INTEGRITY OF THE BUILDING UNDER CONSTRUCTION. THE GENERAL CONTRACTOR IS RESPONSIBLE FOR ALL CONSTRUCTION-RELATED ACTIVITIES.
- 2. FIRE BLOCKING AND FIRE-RESISTANT SHEATHING SHALL BE PROVIDED AS REQUIRED AT CEILINGS, FLOORS, AND ENCLOSED USABLE SPACE UNDER STAIRS.
- 3. ALL WOOD WITHIN 8 INCHES OF THE GROUND SHALL BE PRESSURE TREATED OR COMPRISE A SUITABLY ROT RESISTANT MATERIAL. METAL CONNECTIONS WHICH TOUCH THIS WOOD SHOULD BE GALVANIZED OR STAINLESS STEEL.
- $4\ PROVIDE\ ADEQUATE\ BLOCKING\ AROUND\ CABINTRY,\ PLUMBING\ FIXTURES,\ AND\ OTHER\ APPLICABLE\ AREAS.$
- 5. LUMBER SPECIES AND GRADE SHEATHING SPECIFICATION -- OSB CAN REPLACE PLYWOOD SHEATHING
- 6. ANY PREFABRICATED ROOF TRUSSES MUST BE DESIGNED, CONSTRUCTED, AND CERTIFIED ACCORDING TO MANUFACTURERS' REQUIREMENTS.

ELECTRICAL / HVAC NOTES

- ELECTRICAL / HVAC SYSTEMS ARE TO BE INSTALLED ON A DESIGN-BUILD
 BASIS. ELECTRICAL SYMBOLS IN DRAWINGS SHOW BASIC FIXTURE LAYOUTS.
- 2. IT IS RECOMMENDED THAT A RADIANT FLOOR SYSTEM BE INSTALLED BETWEEN THE FLOOR JOISTS.
- 3. SMOKE DETECTORS AND CARBON MONOXIDE DETECTORS SHALL BE INSTALLED PER CODE. RADON TESTING IS HIGHLY RECOMMENDED.

PLUMBING NOTES

- 1. PLUMBING SYSTEMS TO BE INSTALLED ON A DESIGN-BUILD BASIS. PLUMBNG SYMBOLS WITHIN DRAWINGS SHOW BASIC LAYOUTS OF FIXTURES.
- 2. REFRAIN FROM LOCATING PIPES WITHIN INSULATED EXTERIOR WALLS.
- 3. EXTERIOR PLUMBING AND SEPTIC SYSTEMS TO BE INSTALLED BEFORE COMMENCEMENT OF FOUNDATION CONSTRUCTION.
- 4. IT IS RECOMMENDED THAT A GREYWATER SYSTEM AND RAINWATER CISTERN BE INSTALLED BY A LICENSED AND EXPERIENCED PLUMBER.

WEATHERPROOFING NOTES

- 1. DEPICTED WEATHERPROOFING METHODS (SUCH AS SEALANT, CAULKING, AND FLASHING) ARE NOT COMPREHENSIVE. FOLLOW THE REQUIREMENTS AND RECOMMENDATIONS FROM BUILDING CODES, PRODUCT MANUFACTURERS AND AGENCIES THAT DEVELOP STANDARDS.
- 2. PROVIDE MINIMUM R-13 INSULATION IN ALL EXTERIOR WALLS AND R-30 INSULATION AT ROOFS.
- 3. ALL WOOD WITHIN 8 INCHES OF THE GROUND SHALL BE PRESSURE TREATED OR COMPRISE A SUITABLY ROT RESISTANT MATERIAL. METAL CONNECTIONS WHICH TOUCH THIS WOOD SHOULD BE GALVANIZED OR STAINLESS STEEL.
- 4. PVC, VINYL, FIBERGLASS, AND ALUMINUM SHALL BE MINIMALLY USED THROUGHOUT THE CONSTRUCTION. ONLY DECORATIVE TRIM, INSULATION, AND EXTERIOR WINDOWS SHALL COMPRISE THESE MATERIALS.

FINISHES NOTES

- 1. CONTRACTOR TO ENSURE THAT INTERIOR SHEATHING IS FLUSH, CLEAN AND FREE OF DUST AND DEFECTS BEFORE APPLICATION OF PAINT COATINGS
- 2. FLOOR MATERIAL TRANSITIONS OCCUR AT THE CENTERLINE OF DOORS OR FRAMED OPENINGS.
- 3. ANY CUT OR NOTCHED WOOD SHALL BE COATED WITH AN EPOXY SEALER TO PROTECT END GRAINS FROM ABSORBING WATER.
- 4. PROVIDE 1 COAT PRIMER AND 2 FINISH COATS OF PAINT AT INTERIOR AND EXTERIOR SURFACES.
- 5. ALL GLASS SHALL CONFORM WITH HUMAN IMPACT AND SAFETY REQUIREMENTS.
- 6. THE MINIMUM STAIRCASE TREAD SHALL BE 10" AND THE MINIMUM RISER 7.75", UNLESS LOCAL CODES REQUIRE OTHERWISE.
- 7. HANDRAILS TO BE LOCATED 34-38 INCHES ABOVE STAIR TREADS AS MEASURED FROM THE NOSINGS
- 8. GUARDRAILS MUST BE LOCATED ALONG FLOOR SURFACES THAT ARELOCATED 30" OR MORE ABOVE THE FLOOR OR GROUND BELOW.
- 9. DO NOT USE SCREW-ON, NON-OPERABLE WINDOW SHUTTERS. THEY ARE AS TACKY AS CLIP-ON TIES. DO NOT USE VINYL OR ALUMINUM SIDING. THAT WOULD MAKE THIS HOUSE LOOK LIKE A CHEAP PLASTIC TOY. DO NOT DO IT.



OPEN-SOURCE BLUEPRINTS

CAD FILES AVAILABLE www.amatect.com/farmhouse www.commons.wikimedia.org/wiki/File:FarmhouseV-001.svgopenarchitecturenetwork.org/projects/farmhouse

ORIGINAL DESIGNER Jay Osborne, 2014

> Ш S ഗ Z ≥ \bigcirc 0 工 α \geq \supset 0 Y \succ 1 \cap ш α \mathbf{Y} ഗ \circ \propto Ш ≥ 0 \Box Ш \succ 3 $^{\circ}$

REVISION

VERSION 0.01 02-15-2015
\triangle
\triangle
\triangle
\triangle

DATE **02-15-15**


-


SHEET TITLE

PROJECT NOTES

SHEET NO.

A0.2

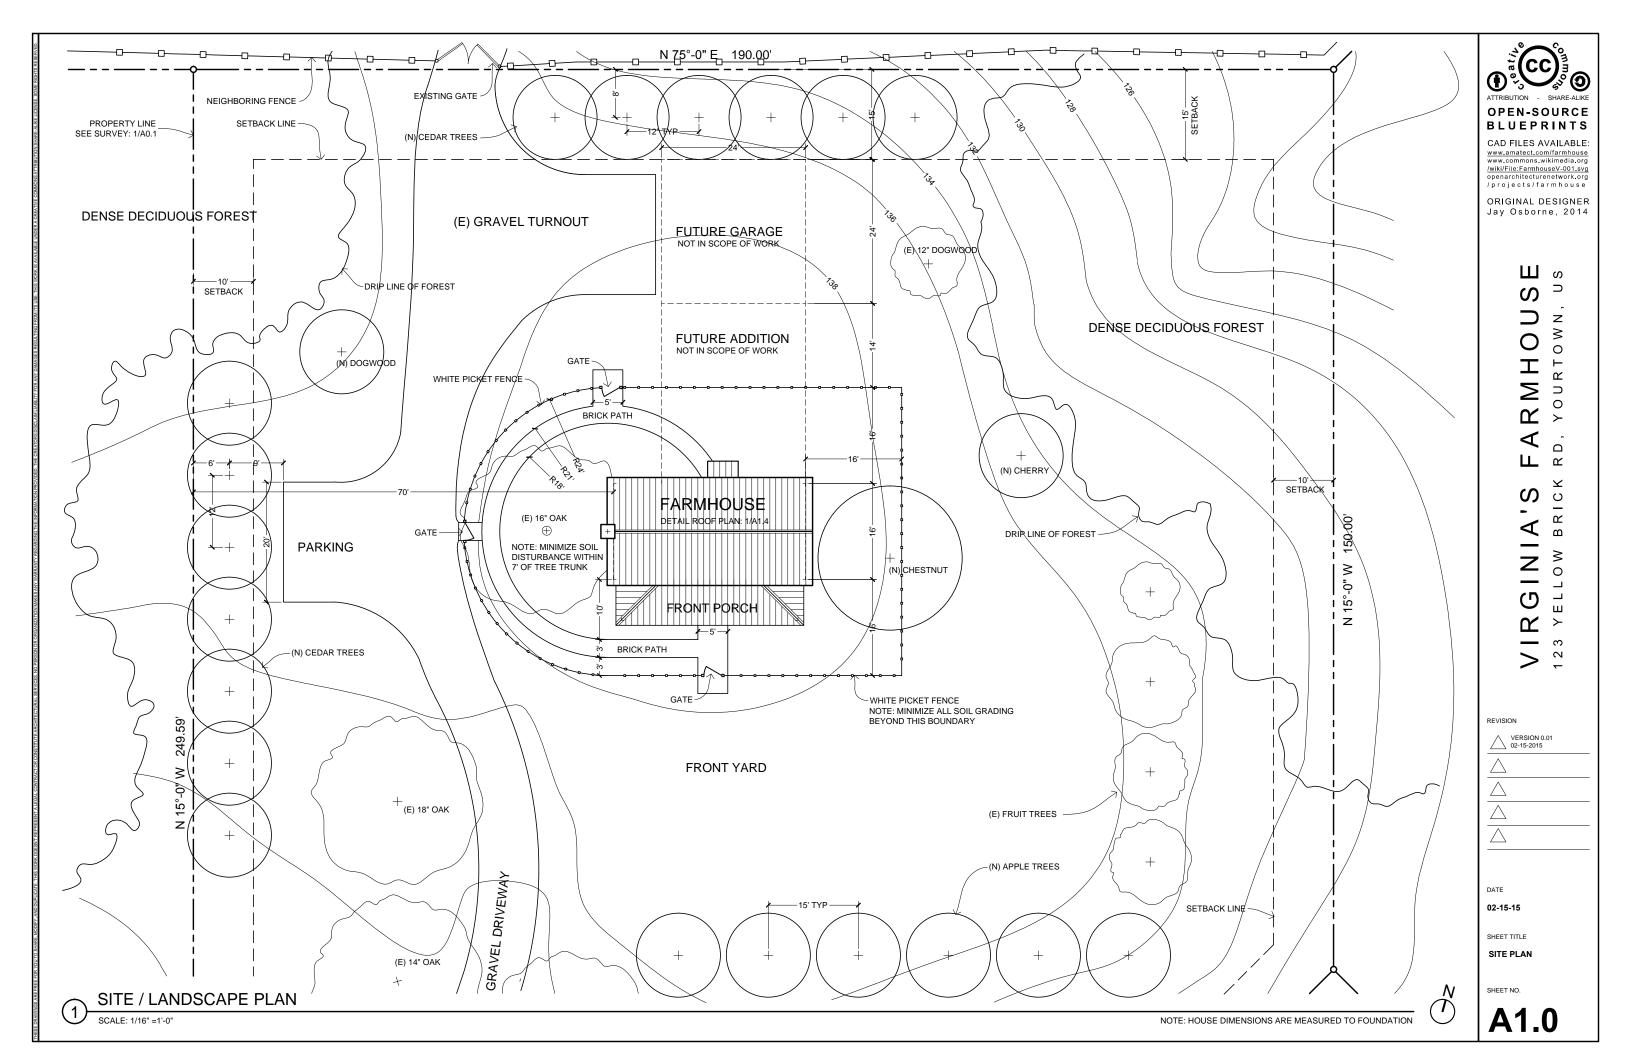

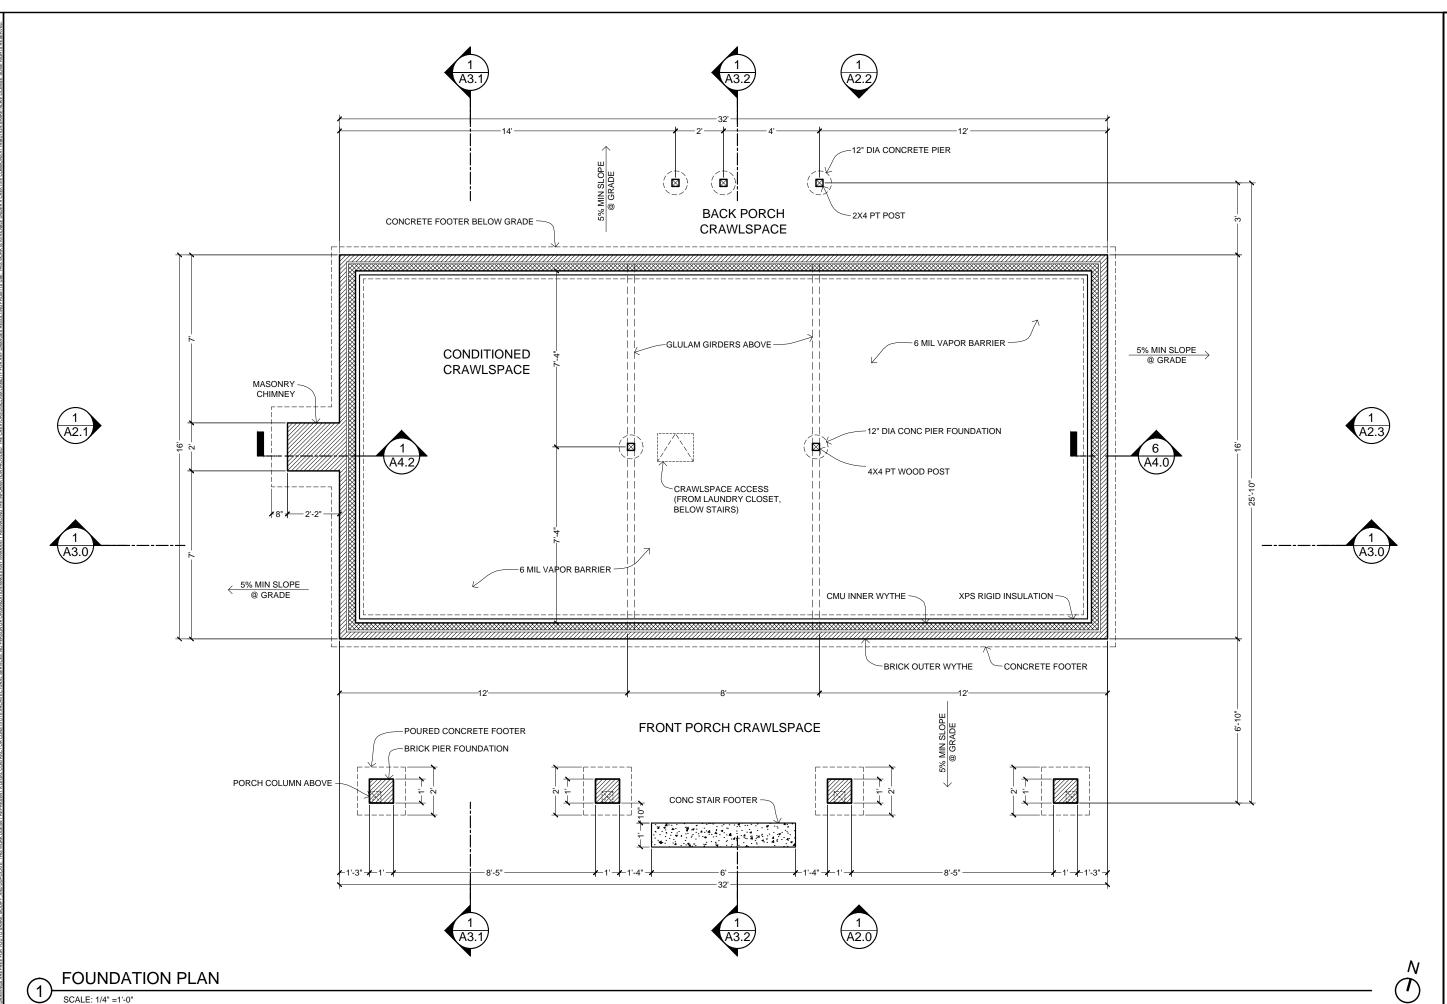

ATTRIBUTION - SHARE-ALIKE

OPEN-SOURCE BLUEPRINTS

CAD FILES AVAILABLE: www.amatect.com/farmhouse www.commons.wikimedia.org /wiki/File:FarmhouseV-001.svg openarchitecturenetwork.org /projects/farmhouse

ORIGINAL DESIGNER Jay Osborne, 2014

> ω Z ≥ 0 0 Η Σ **™** $\cap \circ$ **⊥** ∝ \prec \circ α Ω **∧** 0 G 2 3 7

REVISION

VERSION 0.01 02-15-2015

 \triangle

 $\frac{\triangle}{\triangle}$

 $\frac{\triangle}{\triangle}$


DATE

02-15-15

SHEET TITLE

FOUNDATION PLAN

SHEET NO.

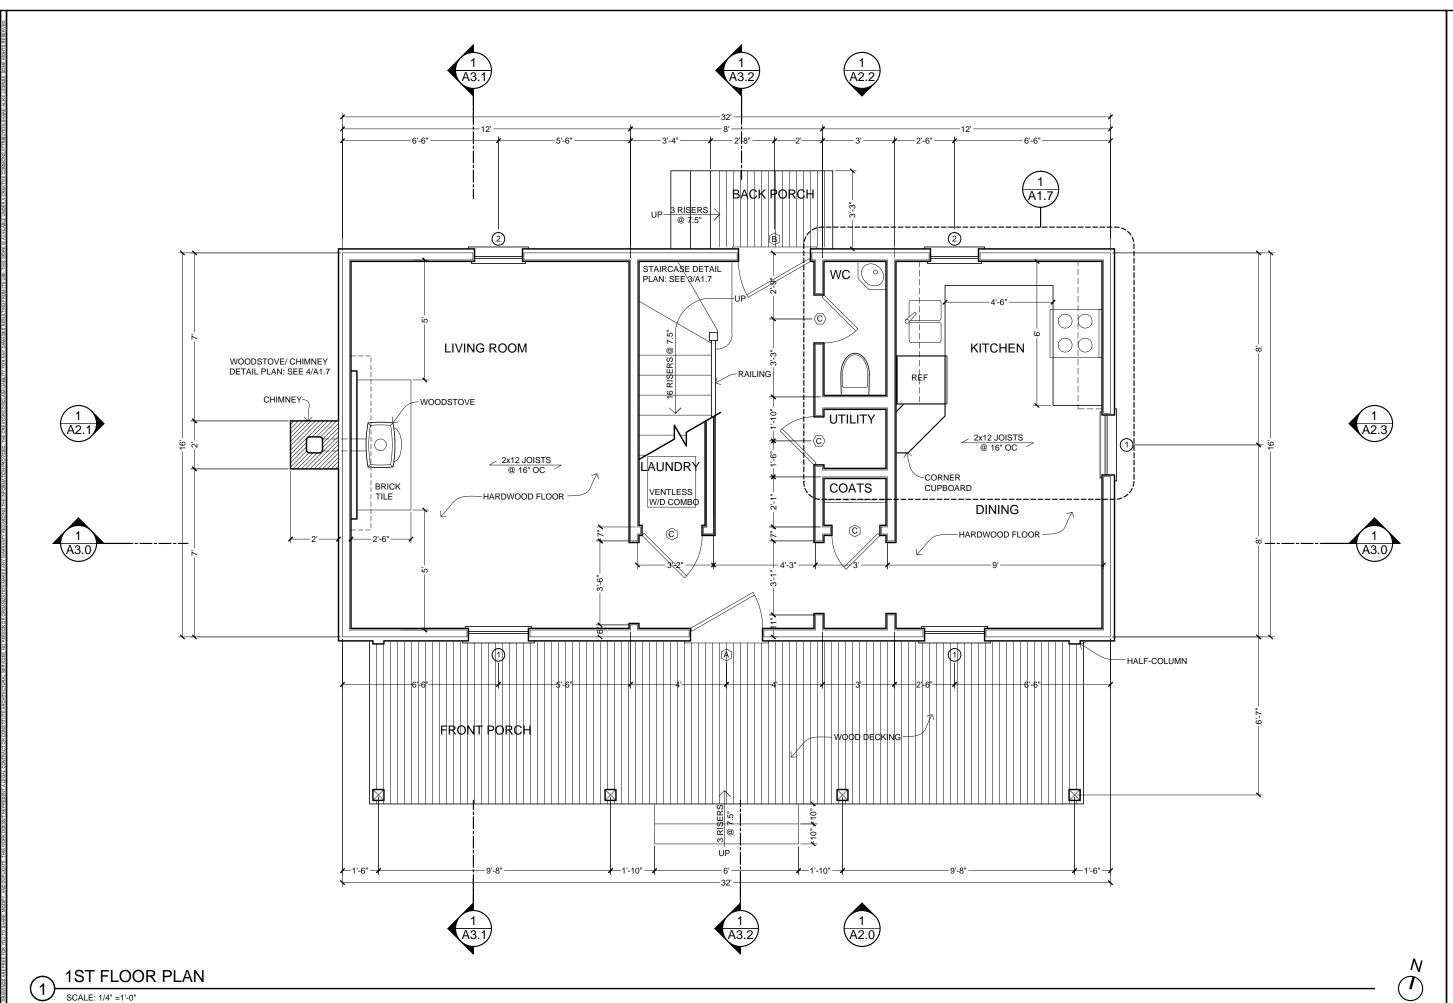



CAD FILES AVAILABLE: www.amatect.com/farmhouse www.commons.wikimedia.org /wiki/File:FarmhouseV-001.svg openarchitecturenetwork.org /projects/farmhouse

ORIGINAL DESIGNER Jay Osborne, 2014

Ш s S Z **≫** 0 Ι Σ \vdash 0 ⋖ **⊥** ∝ \prec <u>ပ</u> α Ω **≫** G \mathcal{L} 3 7

REVISION

VERSION 0.002-15-2015

 \wedge

 \triangle

 $\frac{\triangle}{\triangle}$


DATE

02-15-15

SHEET TITLE

1ST FLOOR PLAN

SHEET NO

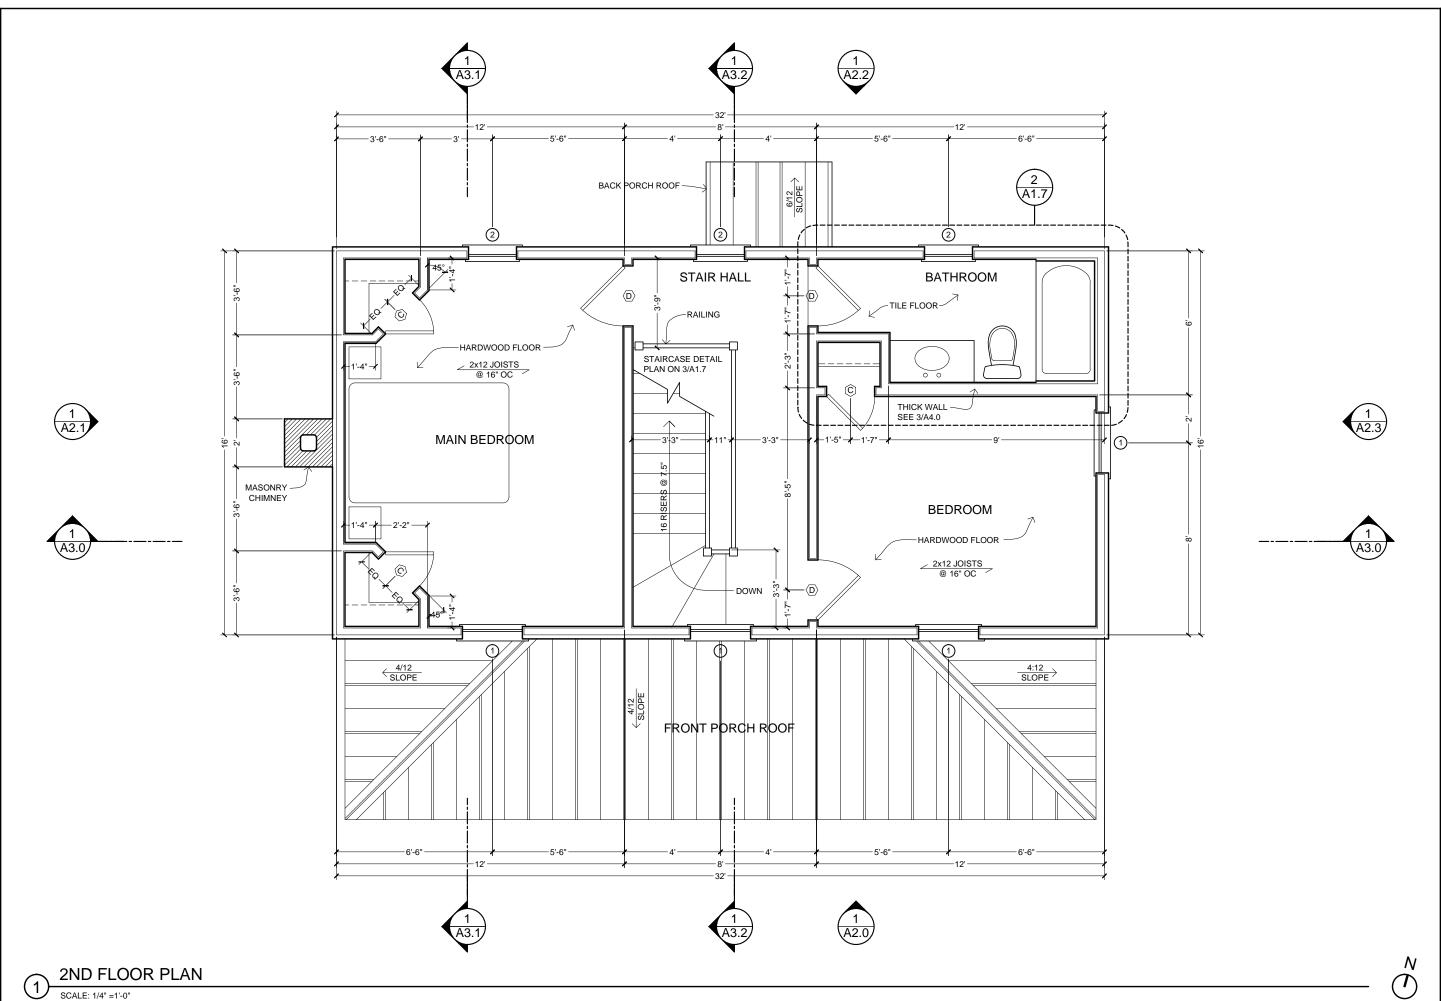



CAD FILES AVAILABLE: www.amatect.com/farmhouse www.commons.wikimedia.org /wiki/File:FarmhouseV-001.svg openarchitecturenetwork.org /projects/farmhouse

ORIGINAL DESIGNER Jay Osborne, 2014

Ш s S Z **≫** 0 Η Σ 0 **⊥** ∝ \prec R C Ω **≫** G \mathcal{L} က

REVISION

VERSION 0.01

 \triangle

 $\frac{\triangle}{\triangle}$


DATE

02-15-15

SHEET TITLE

2ND FLOOR PLAN


SHEET NO

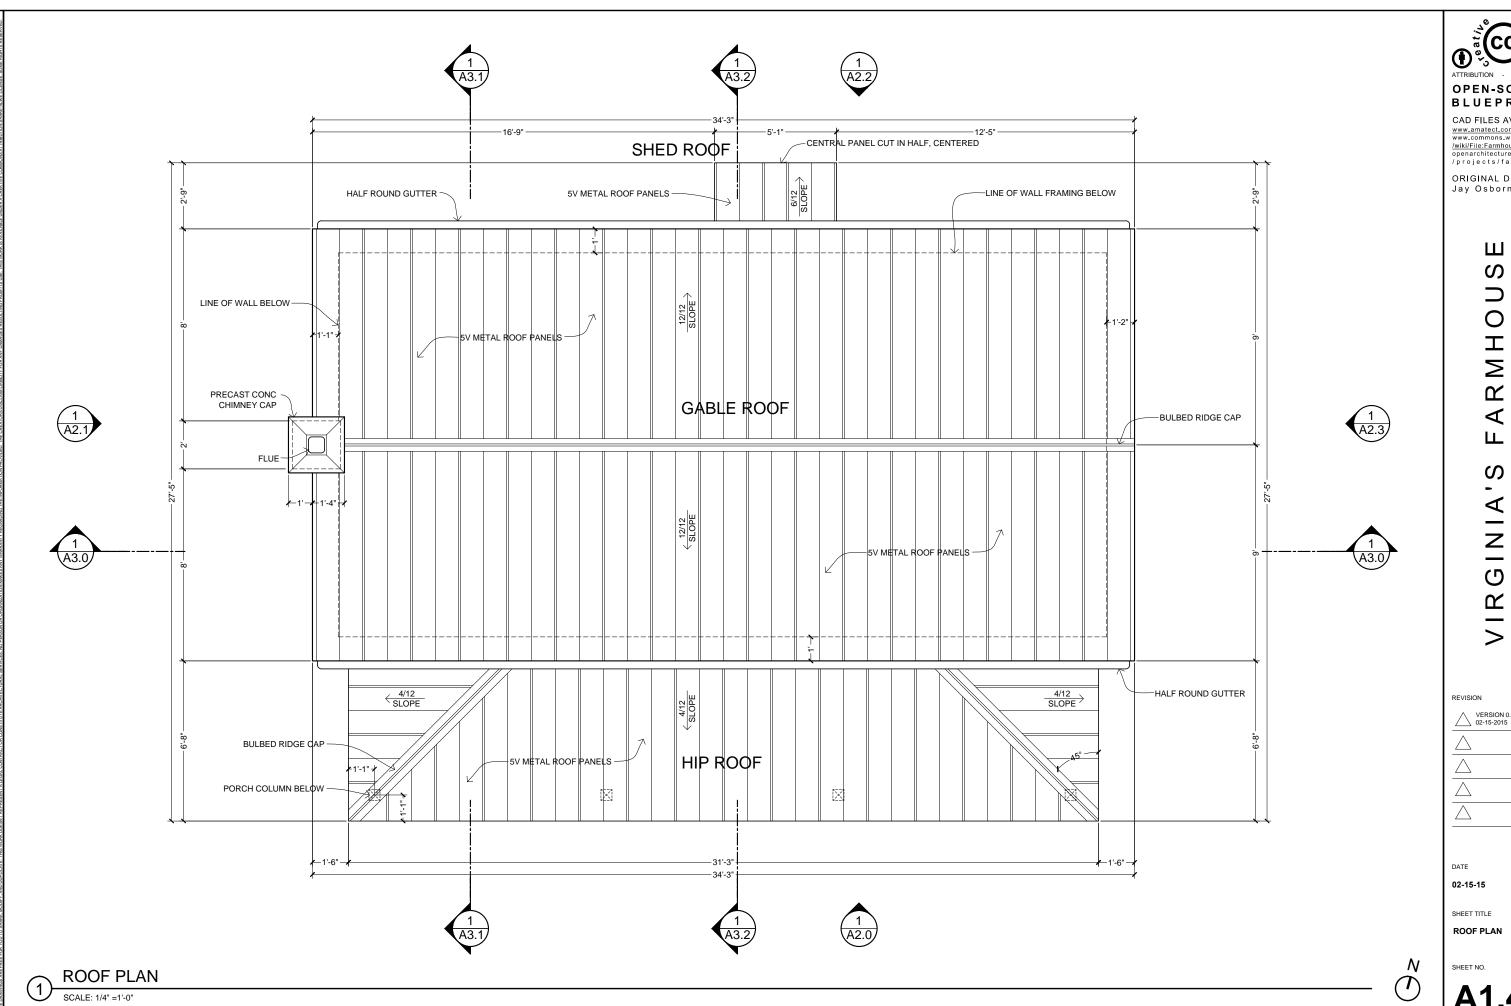

CAD FILES AVAILABLE: www.amatect.com/farmhouse www.commons.wikimedia.org /wiki/File:FarmhouseV-001.svg openarchitecturenetwork.org /projects/farmhouse

ORIGINAL DESIGNER Jay Osborne, 2014

> Ш s Z **≫** $\bigcap_{i \in \mathcal{I}_i} O_i$ **⊥** ∝ \prec R C Ш **≫** က 7

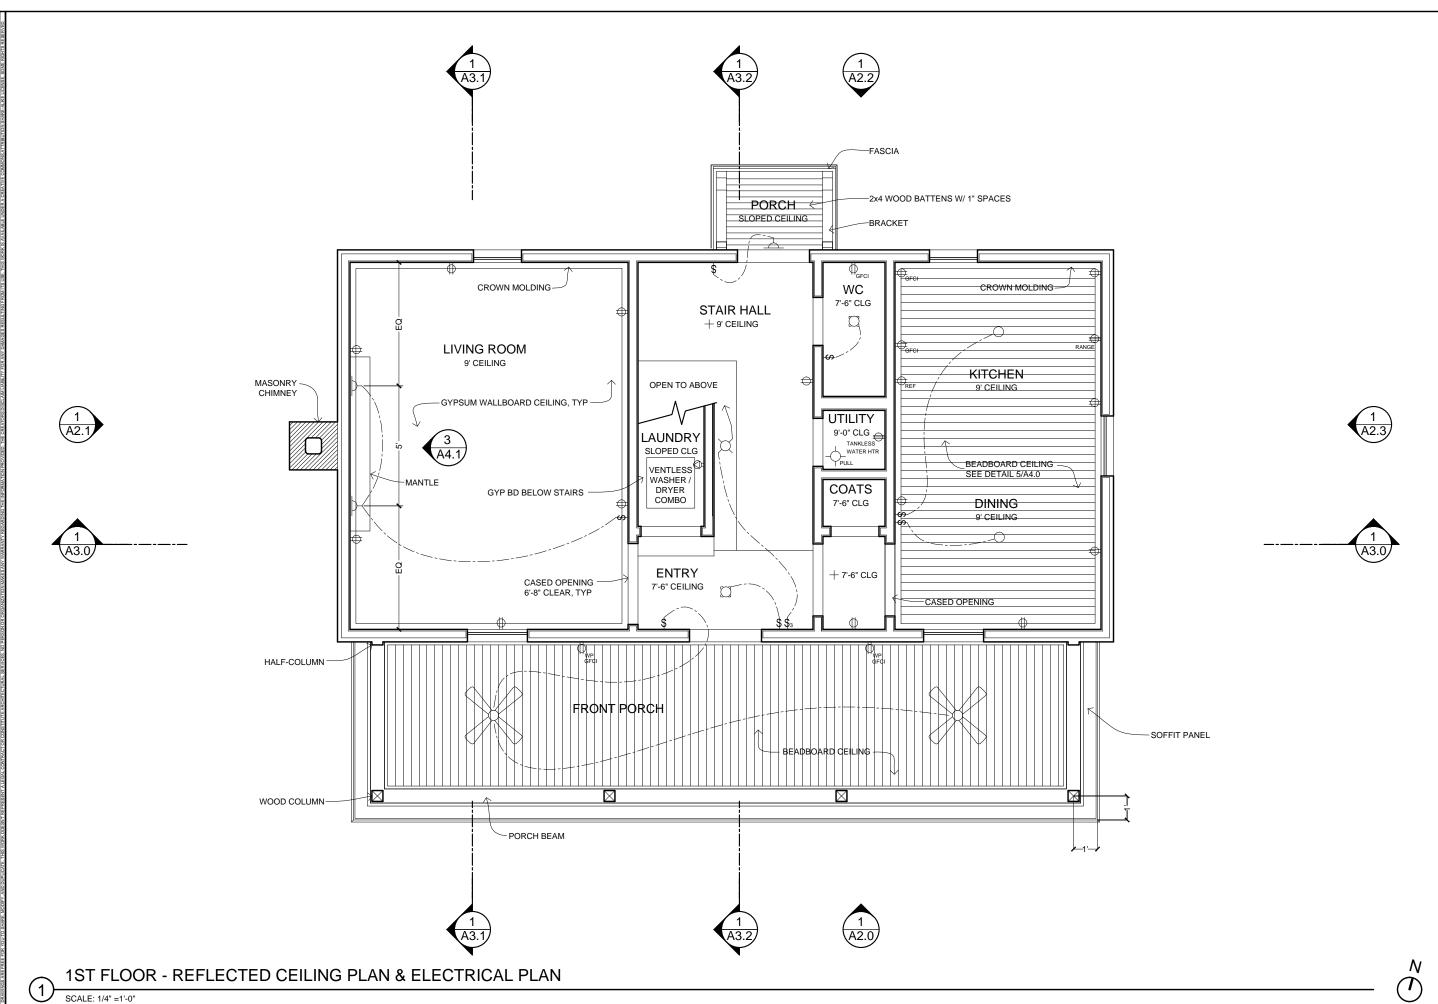



CAD FILES AVAILABLE: www.amatect.com/farmhouse www.commons.wikimedia.org /wiki/File:FarmhouseV-001.svg openarchitecturenetwork.org /projects/farmhouse

ORIGINAL DESIGNER Jay Osborne, 2014

> US Z **≫** 0 Σ $\cap \circ$ **⊥** ≃ \prec <u>ပ</u> α Ω **∧** 0 G 2 \mathcal{C} 7

REVISION

VERSION 0.0 02-15-2015

 \triangle

 $\frac{\triangle}{\triangle}$


DATE

02-15-15

SHEET TITLE

1ST FLOOR RCP / ELECTRICAL PLAN

SHEET NO.

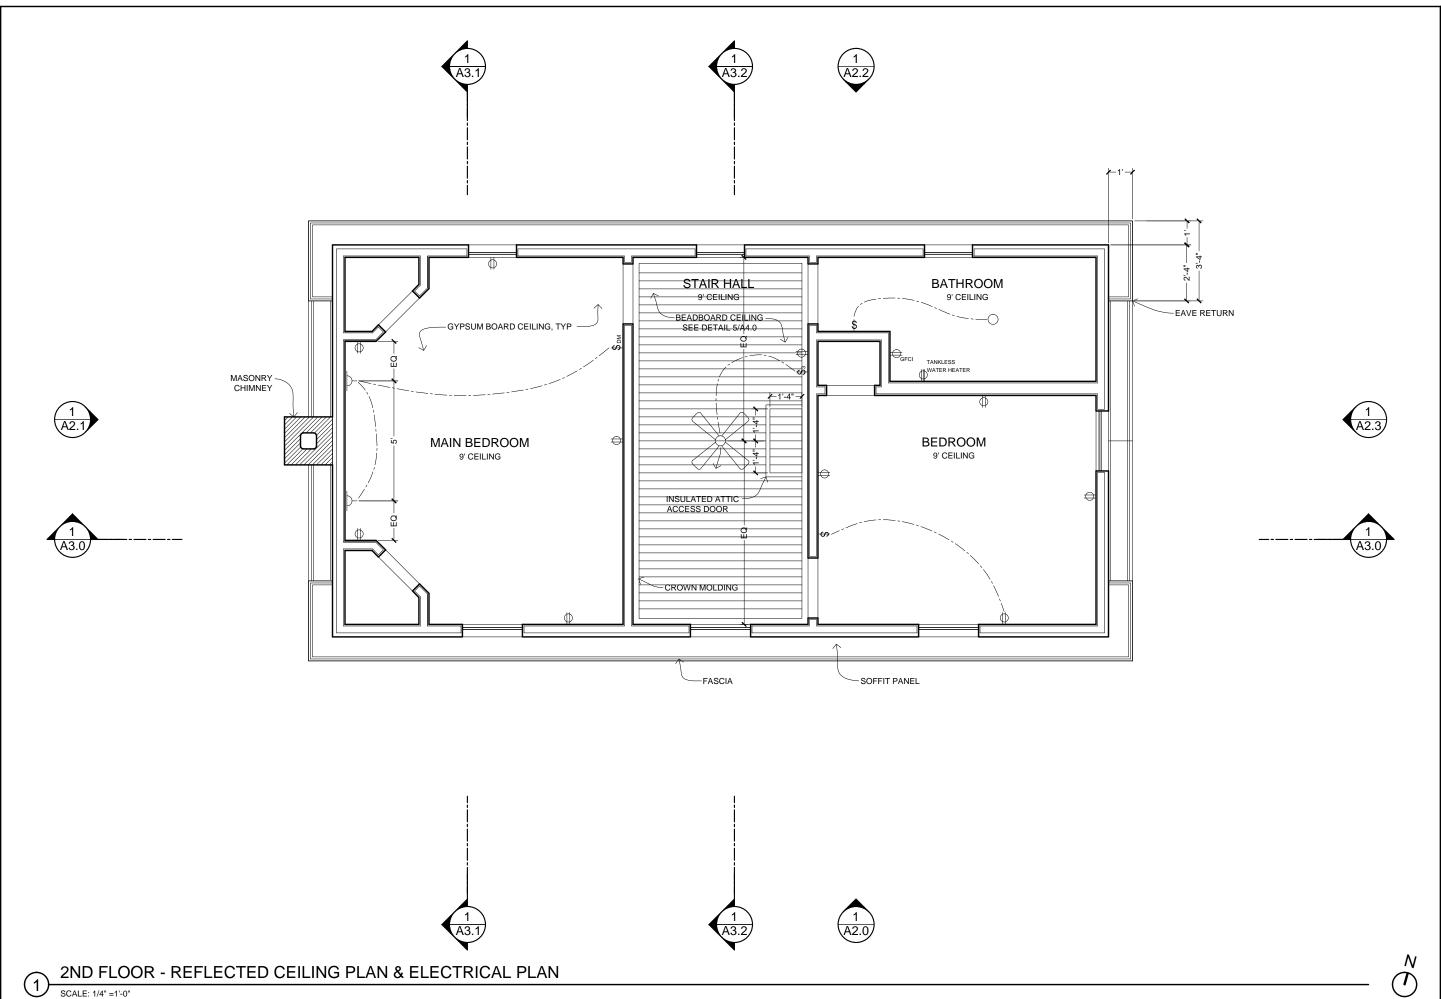



CAD FILES AVAILABLE: www.amatect.com/farmhouse www.commons.wikimedia.org /wiki/File:FarmhouseV-001.svg openarchitecturenetwork.org /projects/farmhouse

ORIGINAL DESIGNER Jay Osborne, 2014

> Ш s Z **≫** 0 Η Σ \vdash 0 **⊥** ∝ \prec R C Ш **≫** G \propto 3 7

REVISION

	\triangle	VERSION 0.01 02-15-2015
_	\triangle	
_	\triangle	
_	\triangle	
_		

DATE

02-15-15

SHEET TITLE

2ND REF. CEILING PLAN / ELECTRICAL PLAN

SHEET NO.


KEY NOTES

FIXTURES (SEE SCHEDULE ON A5.0)

- X-00 REFRIGERATOR
- X-02 KITCHEN SINK
- X-04 RANGE / OVEN
- X-06 RANGE HOOD
- X-08 WATER FAUCET
- X-10 KITCHEN COUNTERTOP
- X-12 FLOOR CABINETS
- X-14 WALL CABINETS
- X-20 TOILET
- X-22 WC TOILET
- X-24 CORNER SINK
- X-26 BATHROOM LAVATORY
- X-28 BATHTUB
- X-30 MIRROR CABINET
- X-40 WOODSTOVE
- X-42 CORNER CUPBOARD
- X-80 TANKLESS WATER HEATER


FINISHES (SEE SCHEDULE ON A5.0)

- (F-60) HARDWOOD FLOOR
- F-62 FLOOR TILE
- F-64 WALL TILE
- (F-68) BASE MOLDING
- (F-70) INTERIOR SHEATHING, PAINTED
- (F-72) WINDOW / DOOR CASING
- F-74 BEADBOARD
- F-76 WAINSCOT CAP
- (F-78) HANDRAIL
- (F-80) NEWEL POST

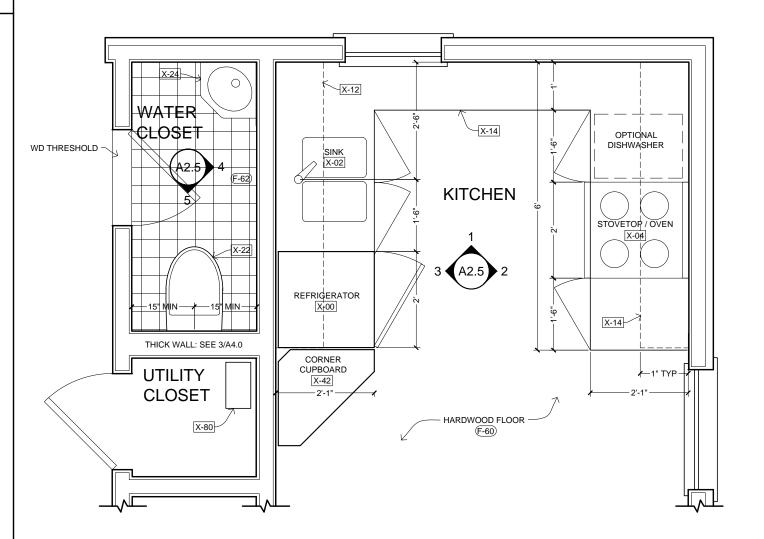


KITCHEN / WATER CLOSET - FLOOR PLAN DETAIL


NOTE: DIMENSIONS ARE TO FINISHES

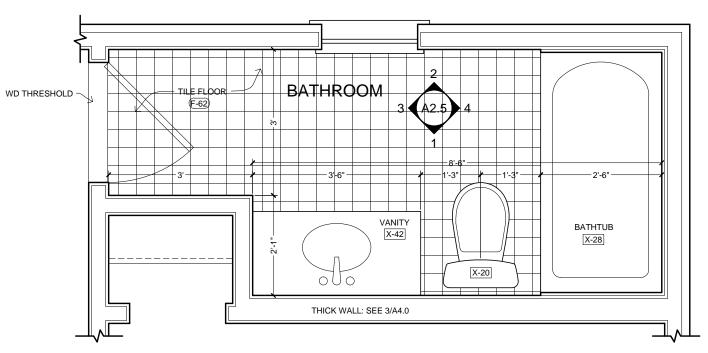

BATHROOM FLOOR PLAN DETAIL

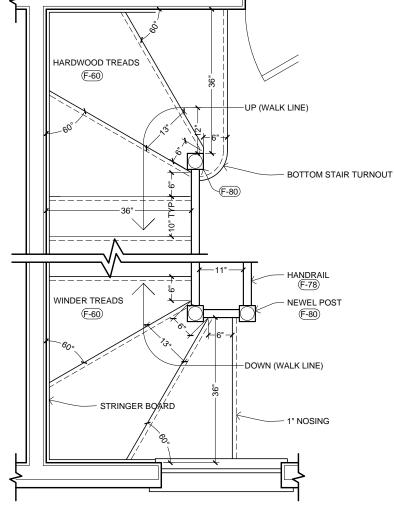

WINDER STAIRS - PLAN DETAIL

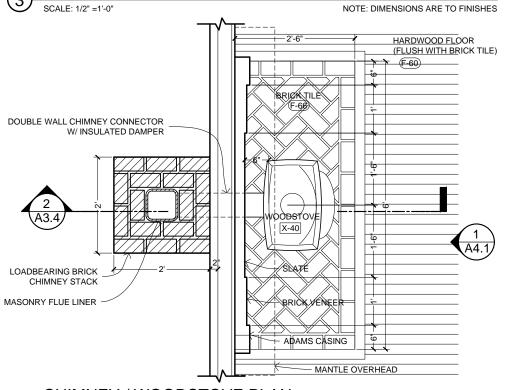

NOTE: DIMENSIONS ARE TO FINISHES

OPEN-SOURCE BLUEPRINTS

CAD FILES AVAILABLE: www.amatect.com/farmhouse www.commons.wikimedia.org /wiki/File:FarmhouseV-001.svg openarchitecturenetwork.org /projects/farmhouse

ORIGINAL DESIGNER Jay Osborne, 2014

> **Ш** σ Z ≥ 0 \supset α $\mathbf{\times}$ \circ \propto 0 Δ 3

REVISION


_	VERSION 0.0 02-15-2015	1
\angle	7	
\angle	7	
$\overline{\angle}$	7	
\angle	7	


DATE 02-15-15


SHEET TITLE


DETAIL PLANS


SHEET NO.

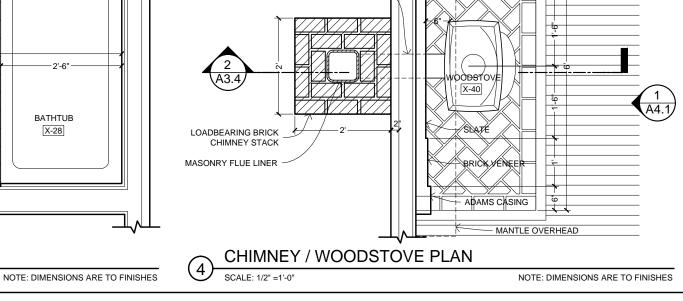

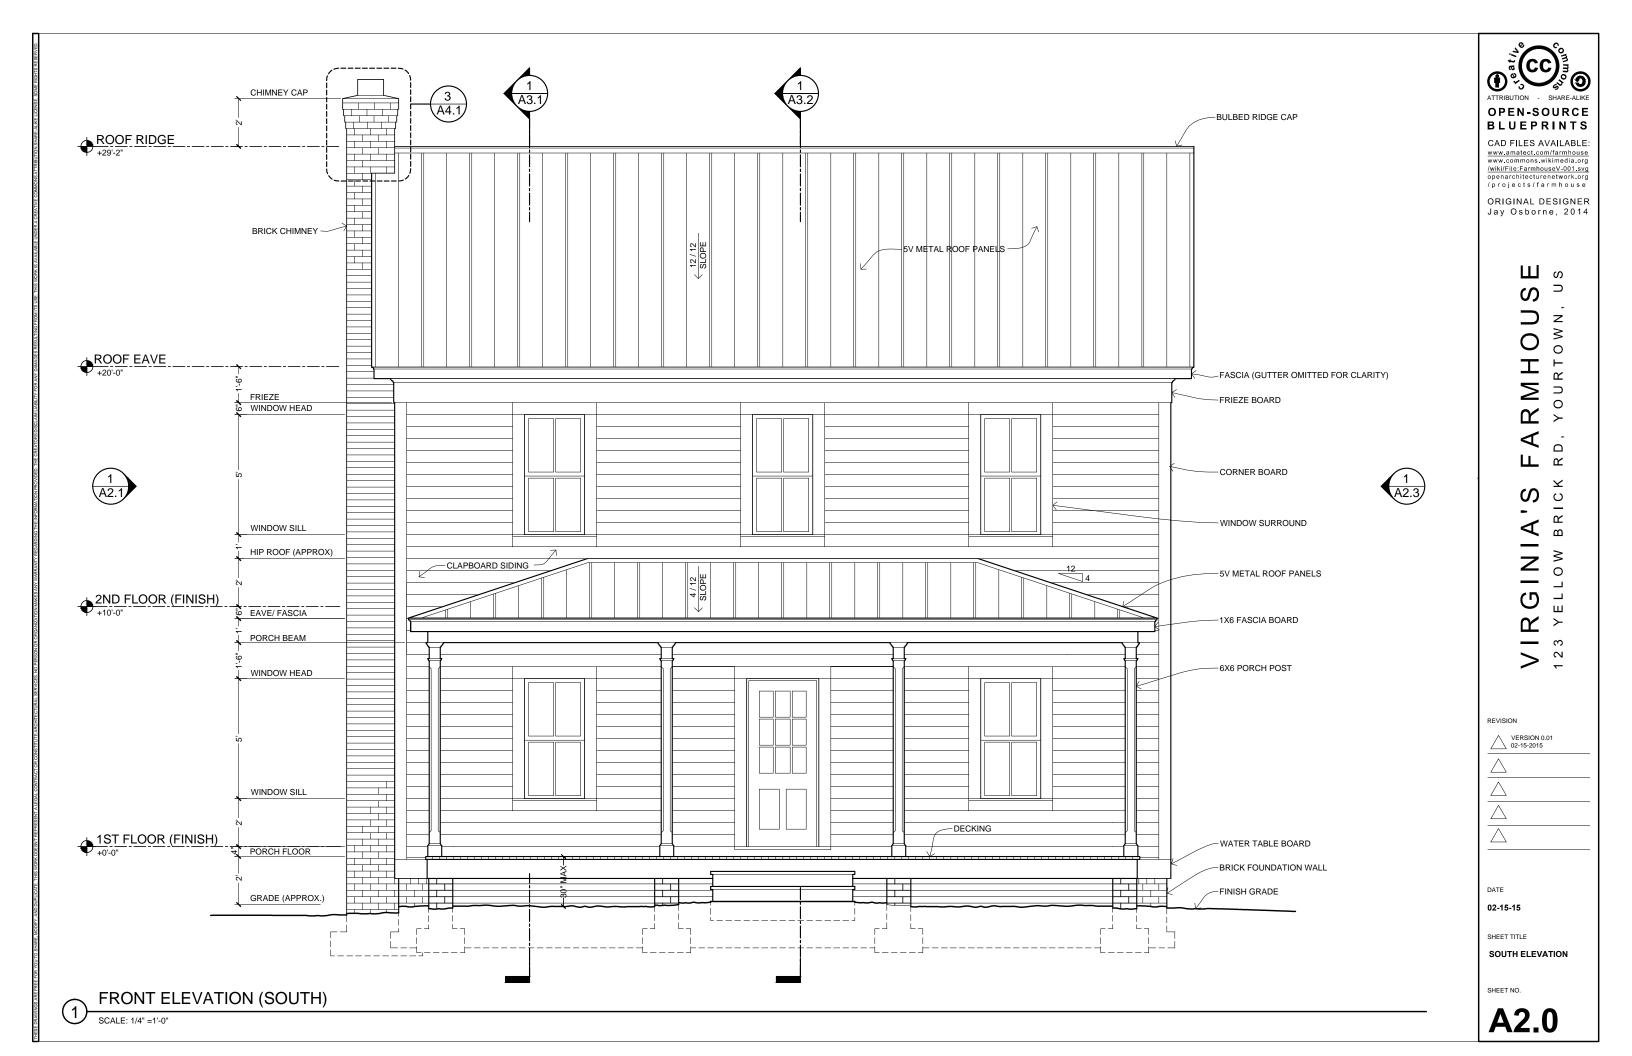

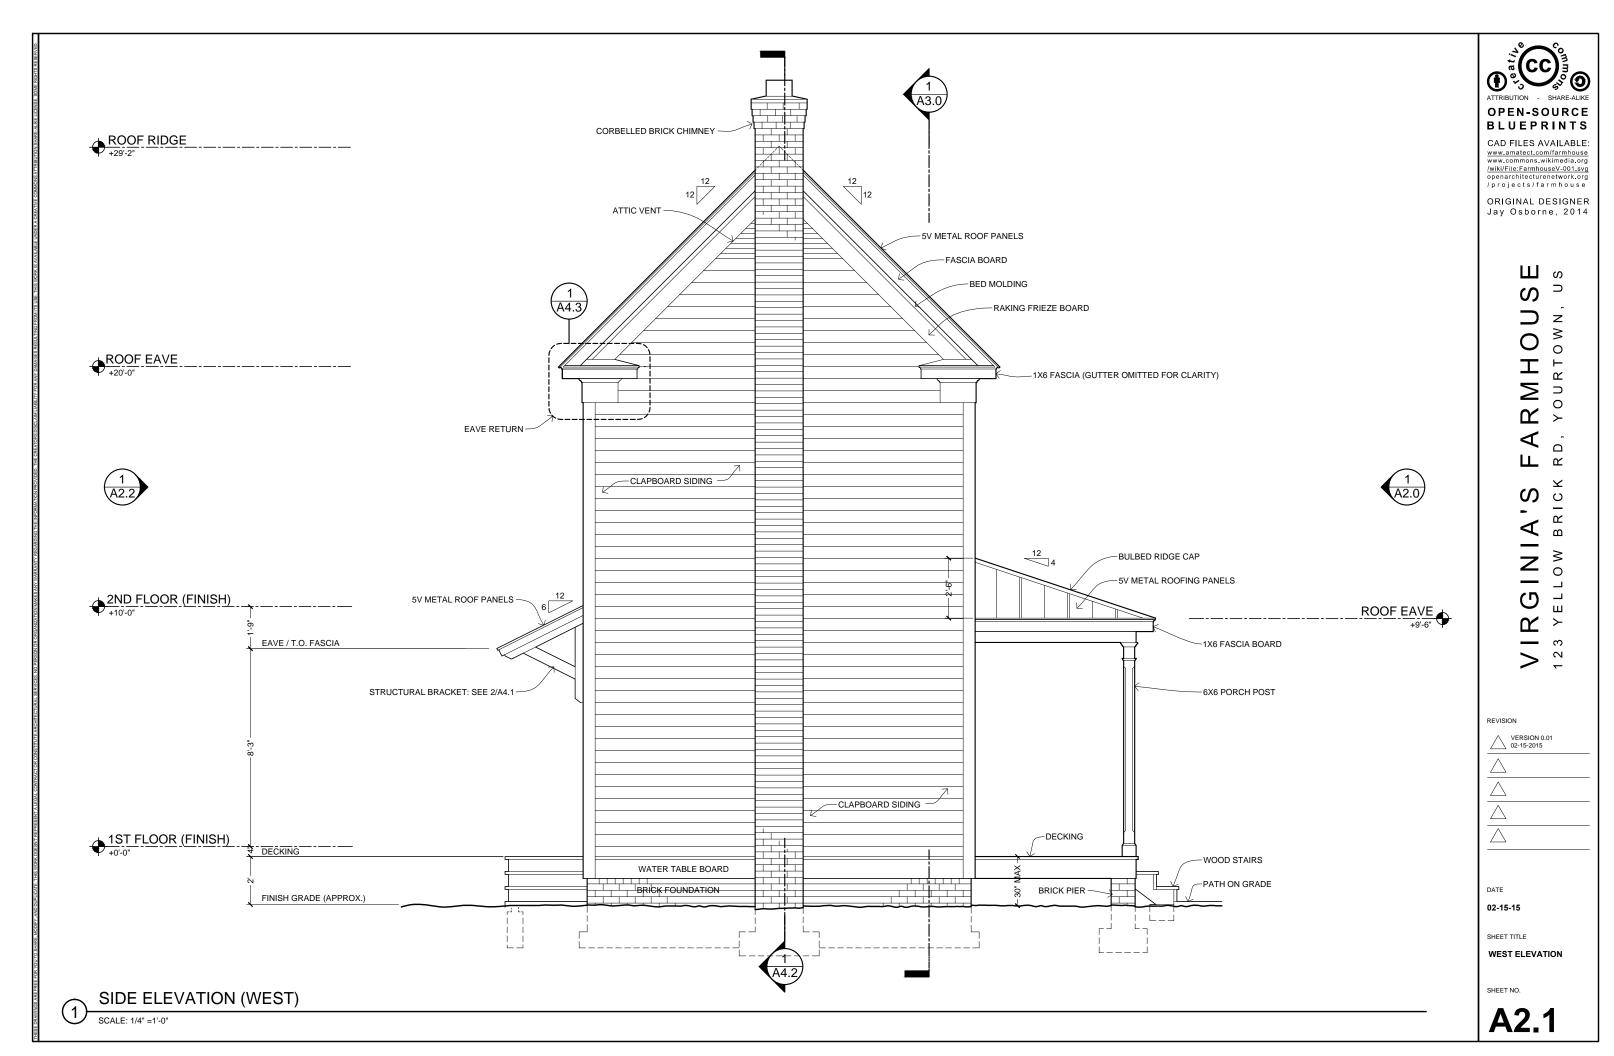

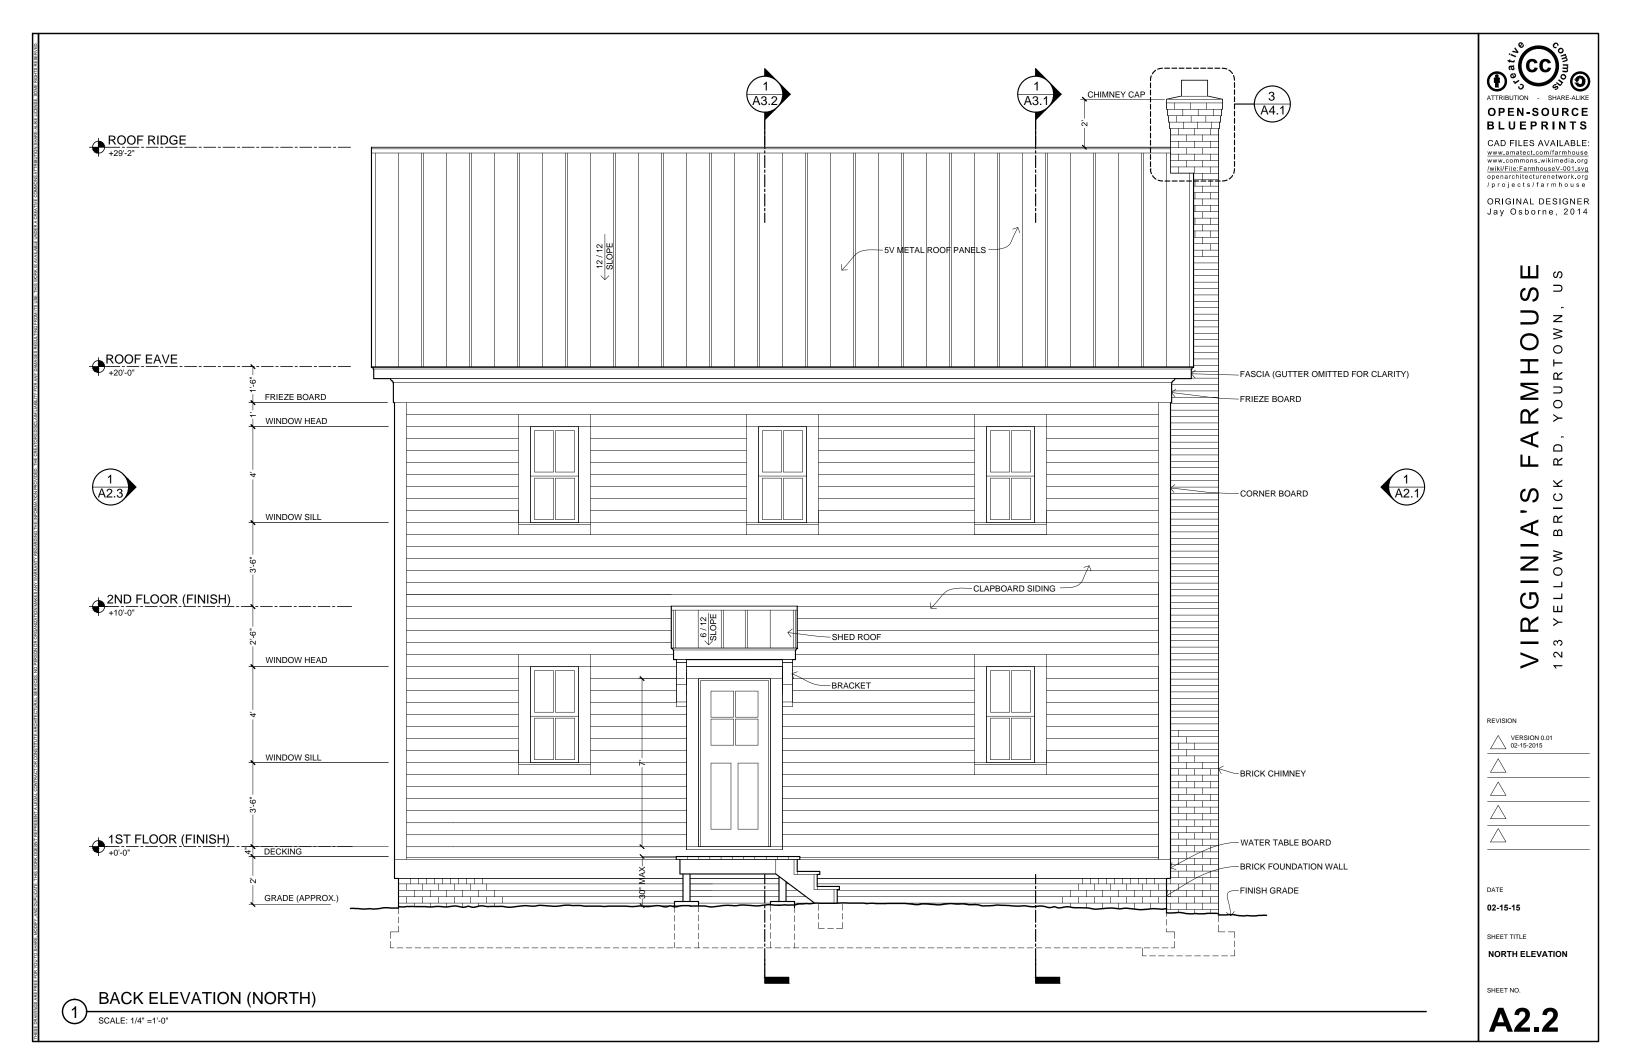

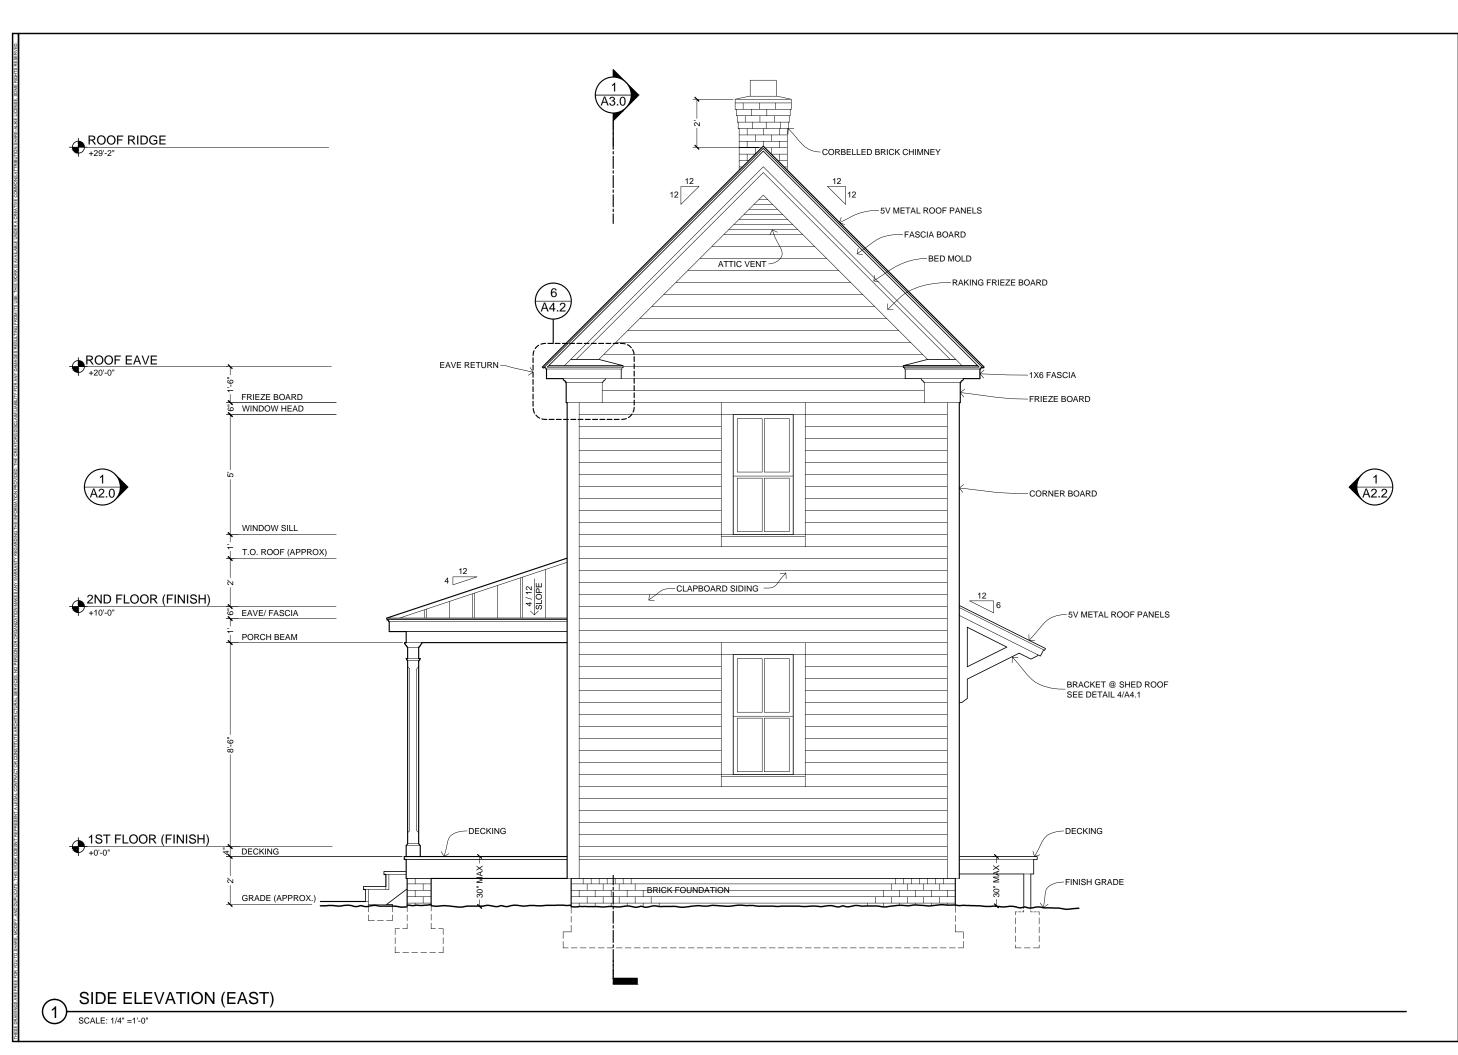



CAD FILES AVAILABLE: www.amatect.com/farmhouse www.commons.wikimedia.org /wiki/File:FarmhouseV-001.svg openarchitecturenetwork.org /projects/farmhouse

ORIGINAL DESIGNER Jay Osborne, 2014

> ω Z ≷ 0 0 ≥ $\cap \circ$ ⋖ **⊥** ∝ \prec <u>ပ</u> α Ω **≫** G 2 3 7

REVISION

VERSION 0.01 02-15-2015

 $\sum_{i=1}^{n}$

 $\frac{\triangle}{\triangle}$

DATE

02-15-15

SHEET TITLE


EAST ELEVATION


SHEET NO.


A2.3

KEY NOTES FIXTURES (SEE SCHEDULE ON A5.0) X-20 TOILET X-26 BATHROOM LAVATORY X-28 BATHTUB X-30 MIRROR CABINET X-42 CORNER CUPBOARD FINISHES (SEE SCHEDULE ON A5.0) (F-62) FLOOR TILE F-64 WALL TILE F-68 BASE MOLDING (F-70) INTERIOR SHEATHING, PAINTED (F-72) WINDOW / DOOR CASING


- F-74 BEADBOARD
- F-76 WAINSCOT CAP

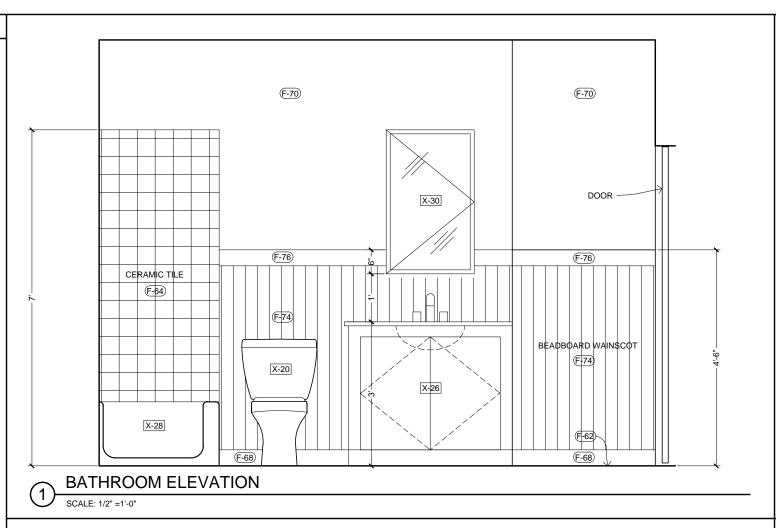

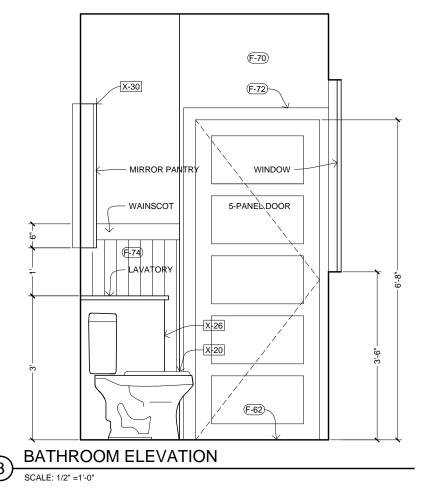

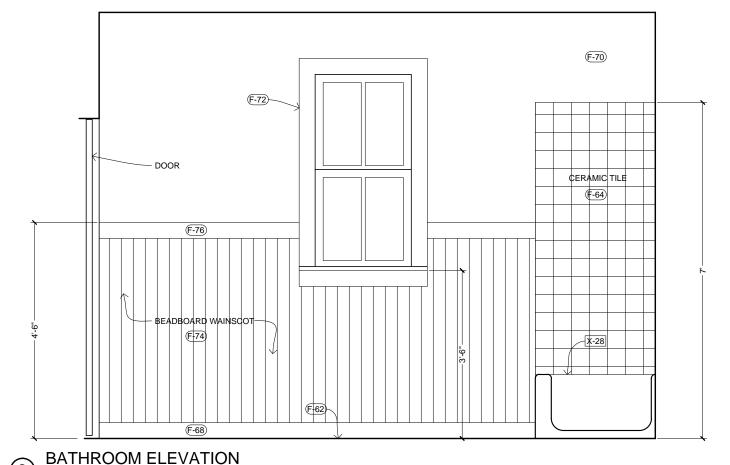

SCALE: 1/2" =1'-0"

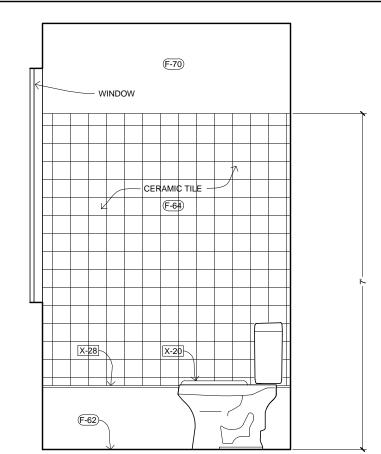

BATHROOM ELEVATION

OPEN-SOURCE BLUEPRINTS

CAD FILES AVAILABLE: www.amatect.com/farmhouse www.commons.wikimedia.org /wiki/Fie:Farmhouse-Voo1:sopenarchitecturenetwork.org /projects/farmhouse

ORIGINAL DESIGNER Jay Osborne, 2014

> US S Z **≫** 0 Σ $\bigcap_{i \in I} O_i$ ⋖ Ω **⊥** ∝ \prec \circ α **∧** 0 G \mathcal{L} 3

REVISION

 \triangle $\overline{\triangle}$

DATE

02-15-15

SHEET TITLE

INTERIOR ELEVATIONS

SHEET NO.

A2.4

KEY NOTES (F-82) (F-82) FIXTURES (SEE SCHEDULE ON A5.0) (F-72) OVERHEAD CABINETS X-00 REFRIGERATOR -6" WOOD SHELVES X-02 KITCHEN SINK X-04 RANGE / OVEN WINDOW X-06 RANGE HOOD X-08 WATER FAUCET X-14 X-14 X-14 X-14 X-10 KITCHEN COUNTERTOP X-12 FLOOR CABINETS X-06 X-14 WALL CABINETS X-22 WC TOILET (F-70) X-24 CORNER SINK (F-70) WOOD BRACKET (F-72)— X-10 X-10 OAK COUNTERTOP FINISHES (SEE SCHEDULE ON A5.0) STOVETOP (F-60) HARDWOOD FLOOR F-76 00 00 F-62 FLOOR TILE F-68 BASE MOLDING OVEN X-12 X-12 X-12 X-12 X-12 (F-70) INTERIOR SHEATHING, PAINTED 12" CABINETS -X-12 X-12 X-12 \X-04 **F-74** (F-72) WINDOW / DOOR CASING CABINET DOORS (F-74) BEADBOARD F-76 WAINSCOT CAP (F-68) (F-82) CROWN MOLDING KITCHEN ELEVATION SCALE: 1/2" =1'-0" KITCHEN ELEVATION (F-82) X-14 (F-70) CORNER SINK ORNER CUPBOARD REFRIGERATOR, (F-76) X-00 X-42 X-24 **F-74**

X-12

KITCHEN ELEVATION

PAINTED GYP BD

F-70

WAINSCOT

F-76

WC ELEVATION

BEADBOARDWAINSCOT

F-62

WATER CLOSET ELEVATION

4

SCALE: 1/2" =1'-0"

X-22

X-14

ATTRIBUTION - SHARE-ALIKE

OPEN-SOURCE
BLUEPRINTS

CAD FILES AVAILABLE:
www.amatect.com/farmhouse

CAD FILES AVAILABLE: www.amatect.com/farmhouse www.commons.wikimedia.org /wiki/File:FarmhouseV-001.svg openarchitecturenetwork.org /projects/farmhouse

ORIGINAL DESIGNER Jay Osborne, 2014

> Шσ S Z ≥ 0 工 ≥ $\bigcap_{i \in I} O_i$ \triangleleft α \checkmark \circ **≫** 0 G \propto 3

REVISION

VERSION 0.01
02-15-2015

DATE


02-15-15


SHEET TITLE

INTERIOR ELEVATIONS

SHEET NO.

A2.5

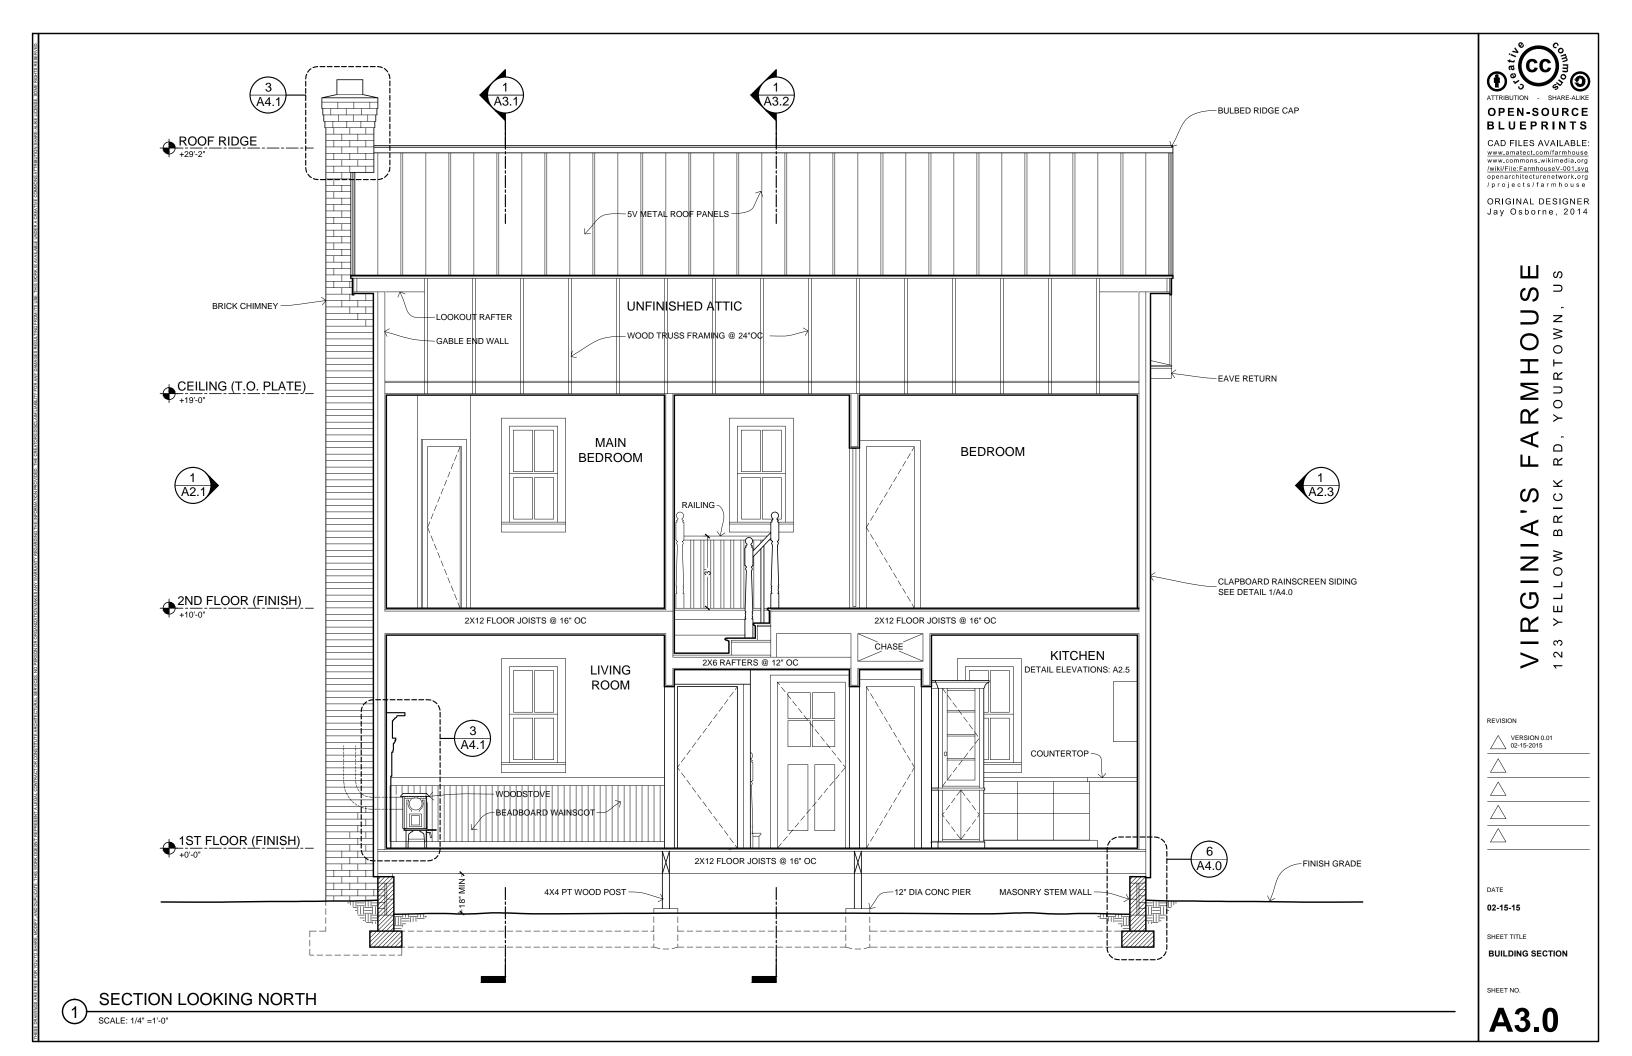

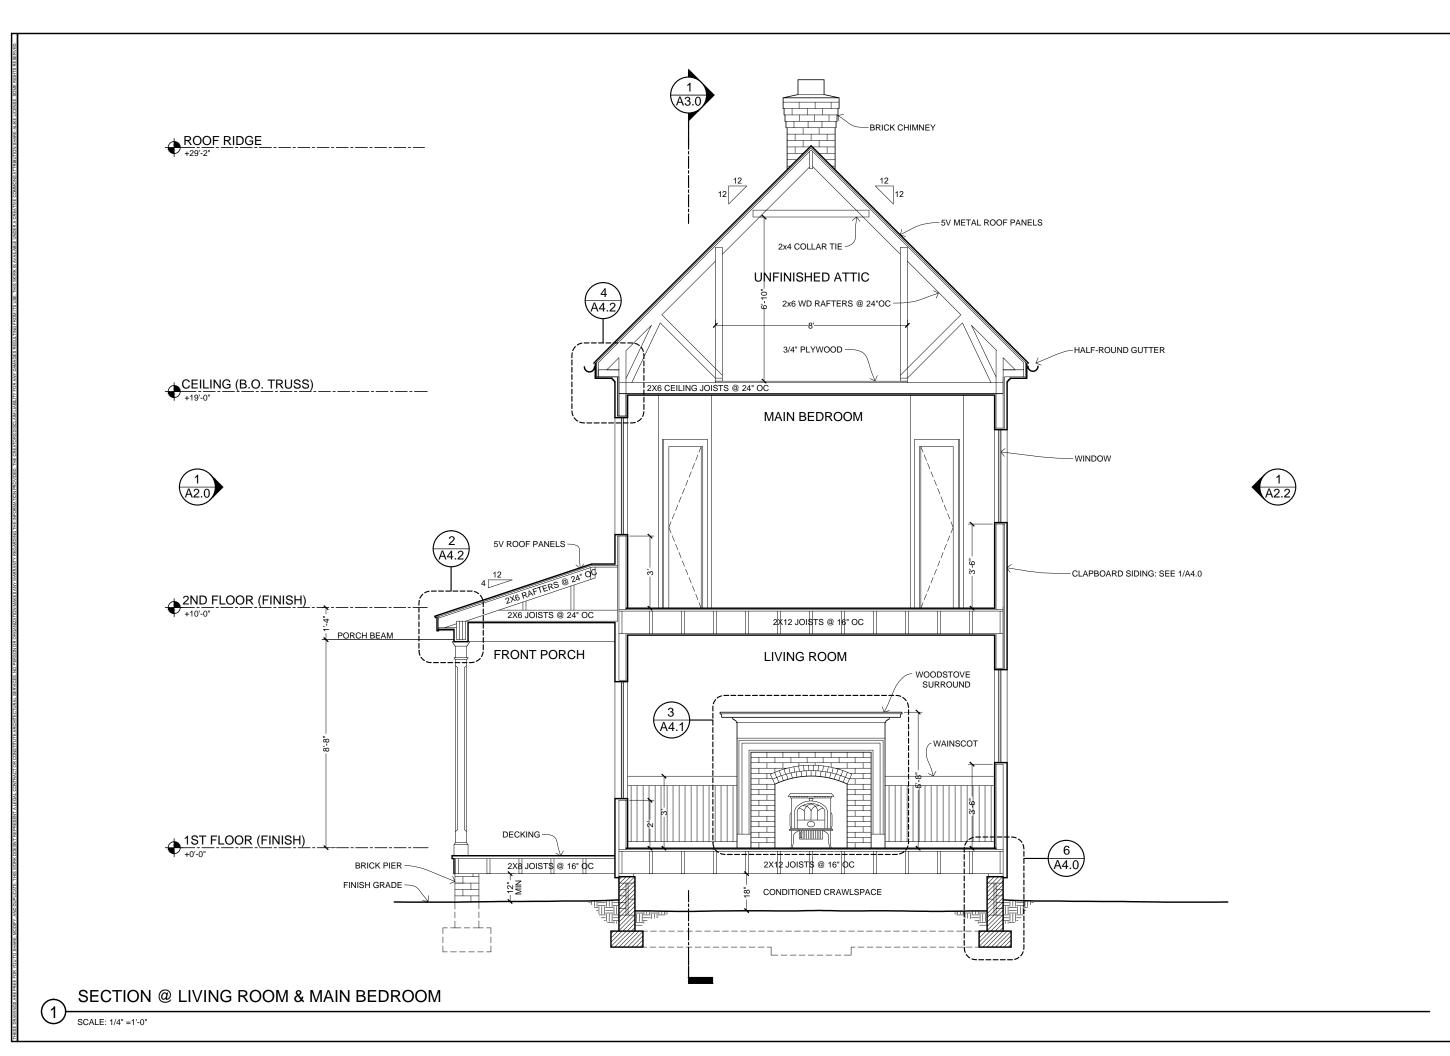



CAD FILES AVAILABLE: www.amatect.com/farmhouse www.commons.wikimedia.org /wiki/File:FarmhouseV-001.svg openarchitecturenetwork.org /projects/farmhouse

ORIGINAL DESIGNER Jay Osborne, 2014

VIRGINIA'S FARMHOUSE
123 YELLOW BRICK RD, YOURTOWN, US

REVISION

VERSION 0.0 02-15-2015

 \wedge

 $\frac{\triangle}{\triangle}$

 \triangle

DATE


02-15-15

SHEET TITLE

BUILDING SECTION

SHEET NO.

A3.1

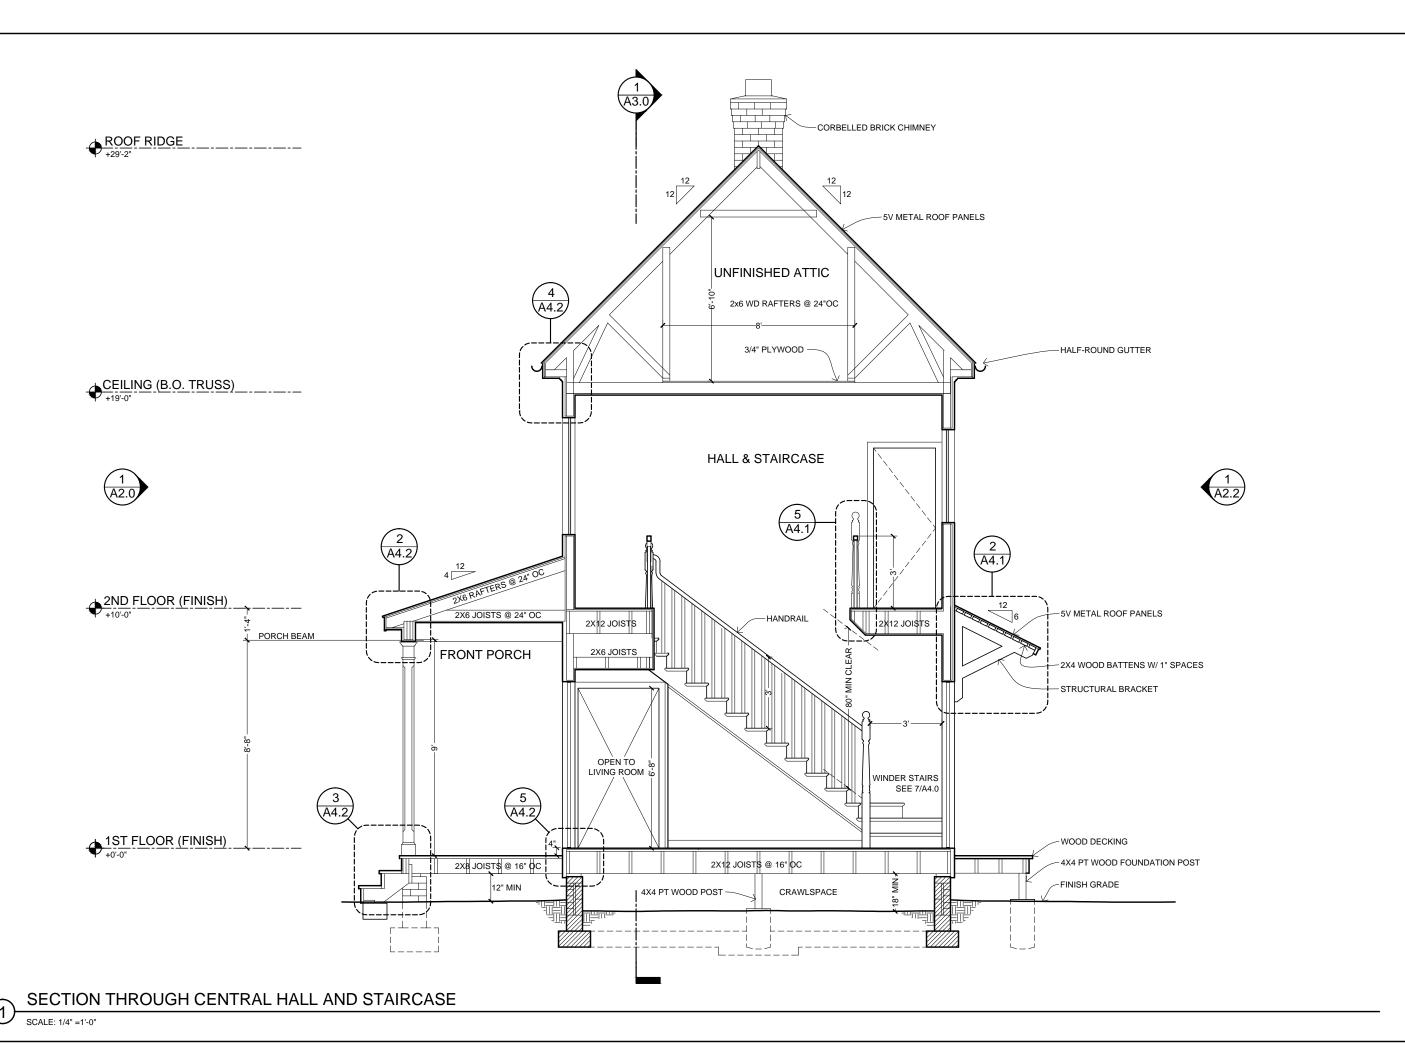



CAD FILES AVAILABLE: www.amatect.com/farmhouse www.commons.wikimedia.org /wiki/File:FarmhouseV-001.svg openarchitecturenetwork.org /projects/farmhouse

ORIGINAL DESIGNER Jay Osborne, 2014

VIRGINIA'S FARMHOUSE

REVISION

VERSION 0. 02-15-2015

 \triangle

 \triangle

DATE


02-15-15


SHEET TITLE


SECTIONS

SHEET NO.

A3.2

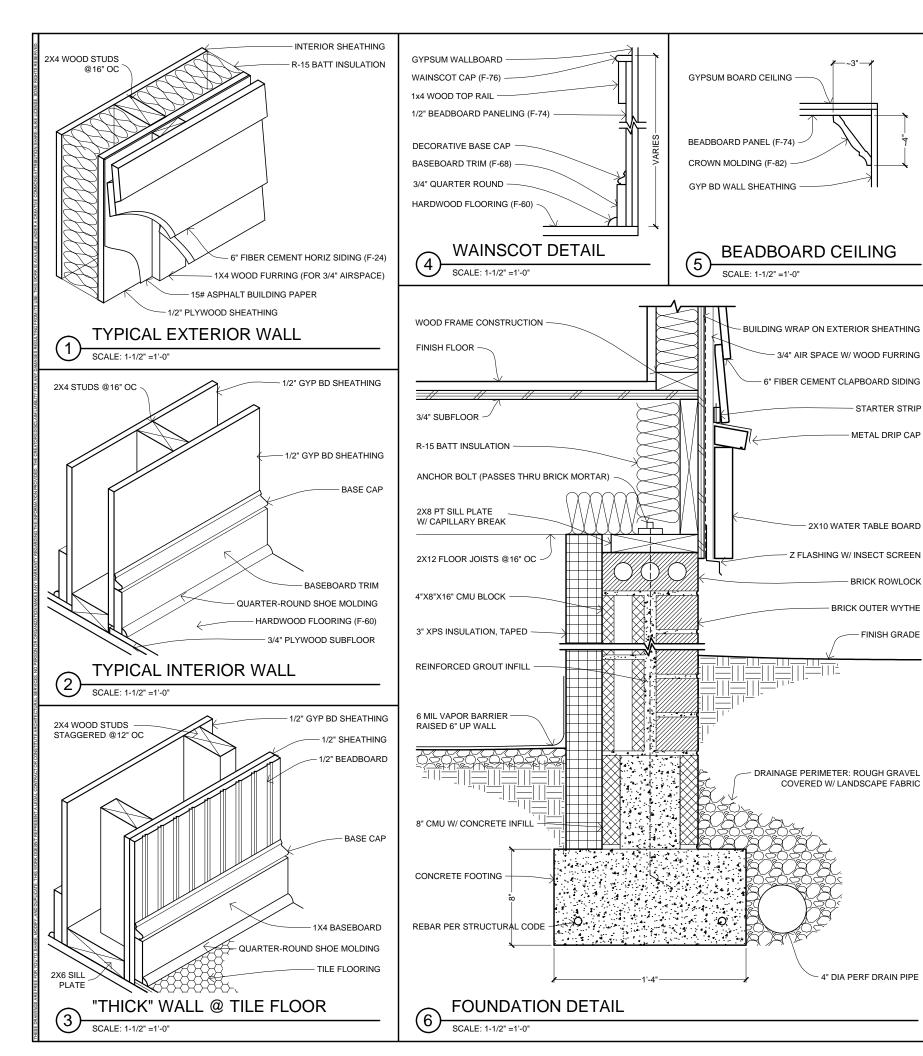

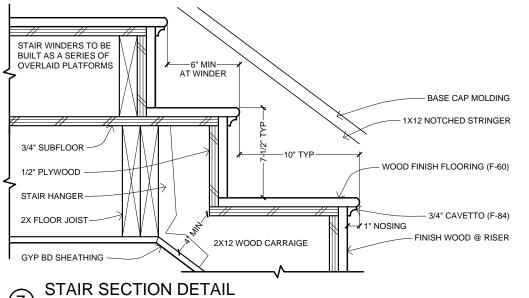

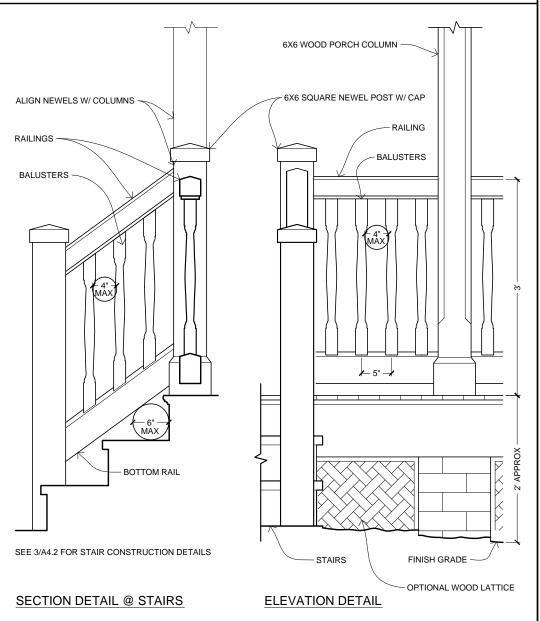

OPTIONAL PORCH BALUSTRADE



OPEN-SOURCE BLUEPRINTS CAD FILES AVAILABLE

www.amatect.com/farmhouse www.commons.wikimedia.org /wiki/File:FarmhouseV-001.svg openarchitecturenetwork.org /projects/farmhouse

ORIGINAL DESIGNER Jay Osborne, 2014

IRGINIA'S FARMHOUSE
3 YELLOW BRICK RD, YOURTOWN, US

REVISION

VERSION 0.01 02-15-2015

 \triangle

02-15-15


SHEET TITLE


TYPICAL DETAILS


SHEET NO.

RAILING IS REQUIRED IF PORCH DROPOFF IS MORE THAN 30"

A4.0

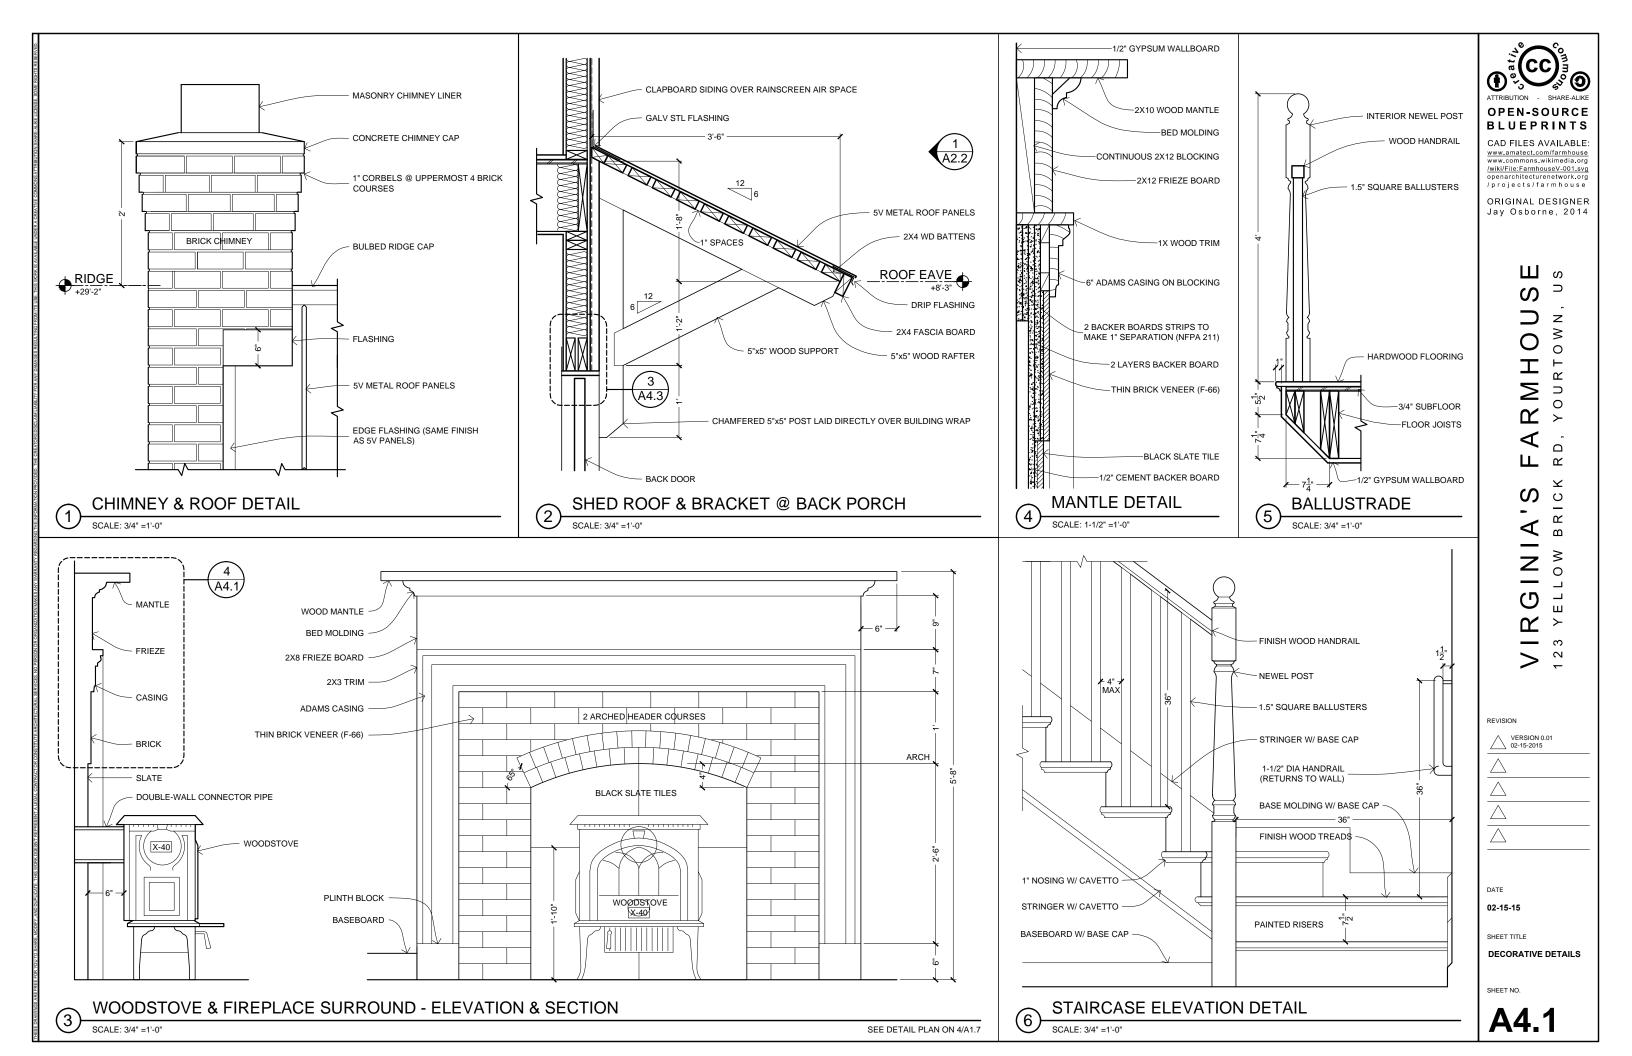

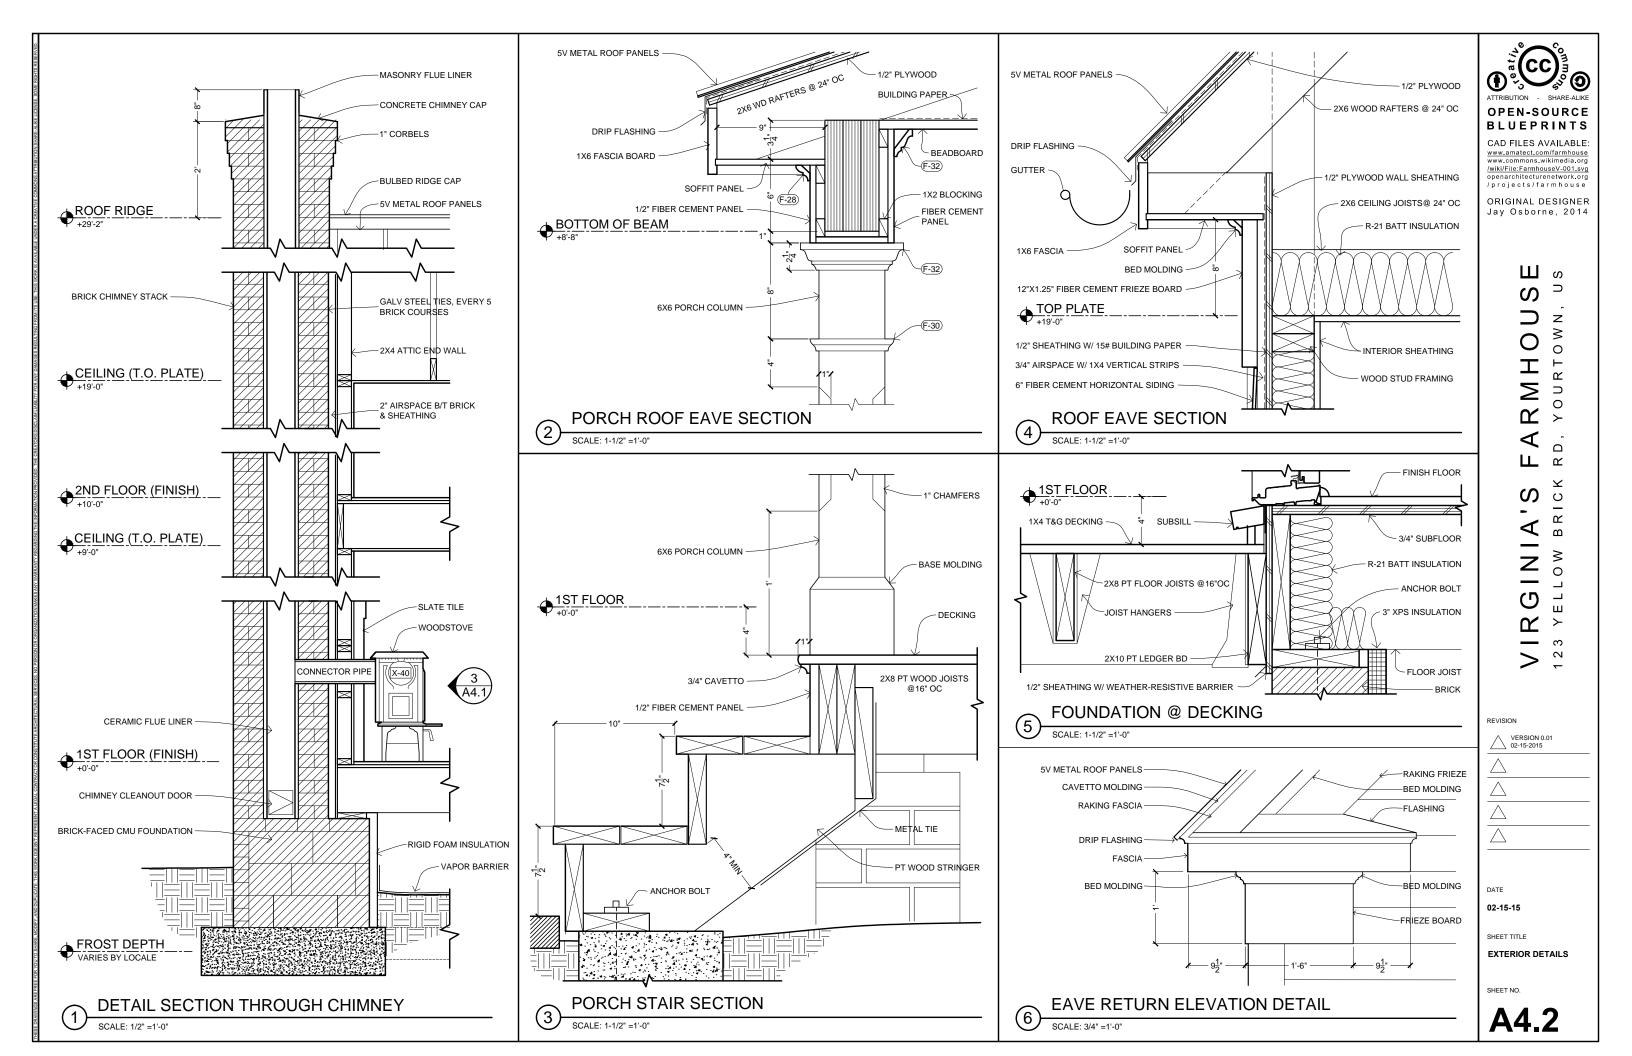

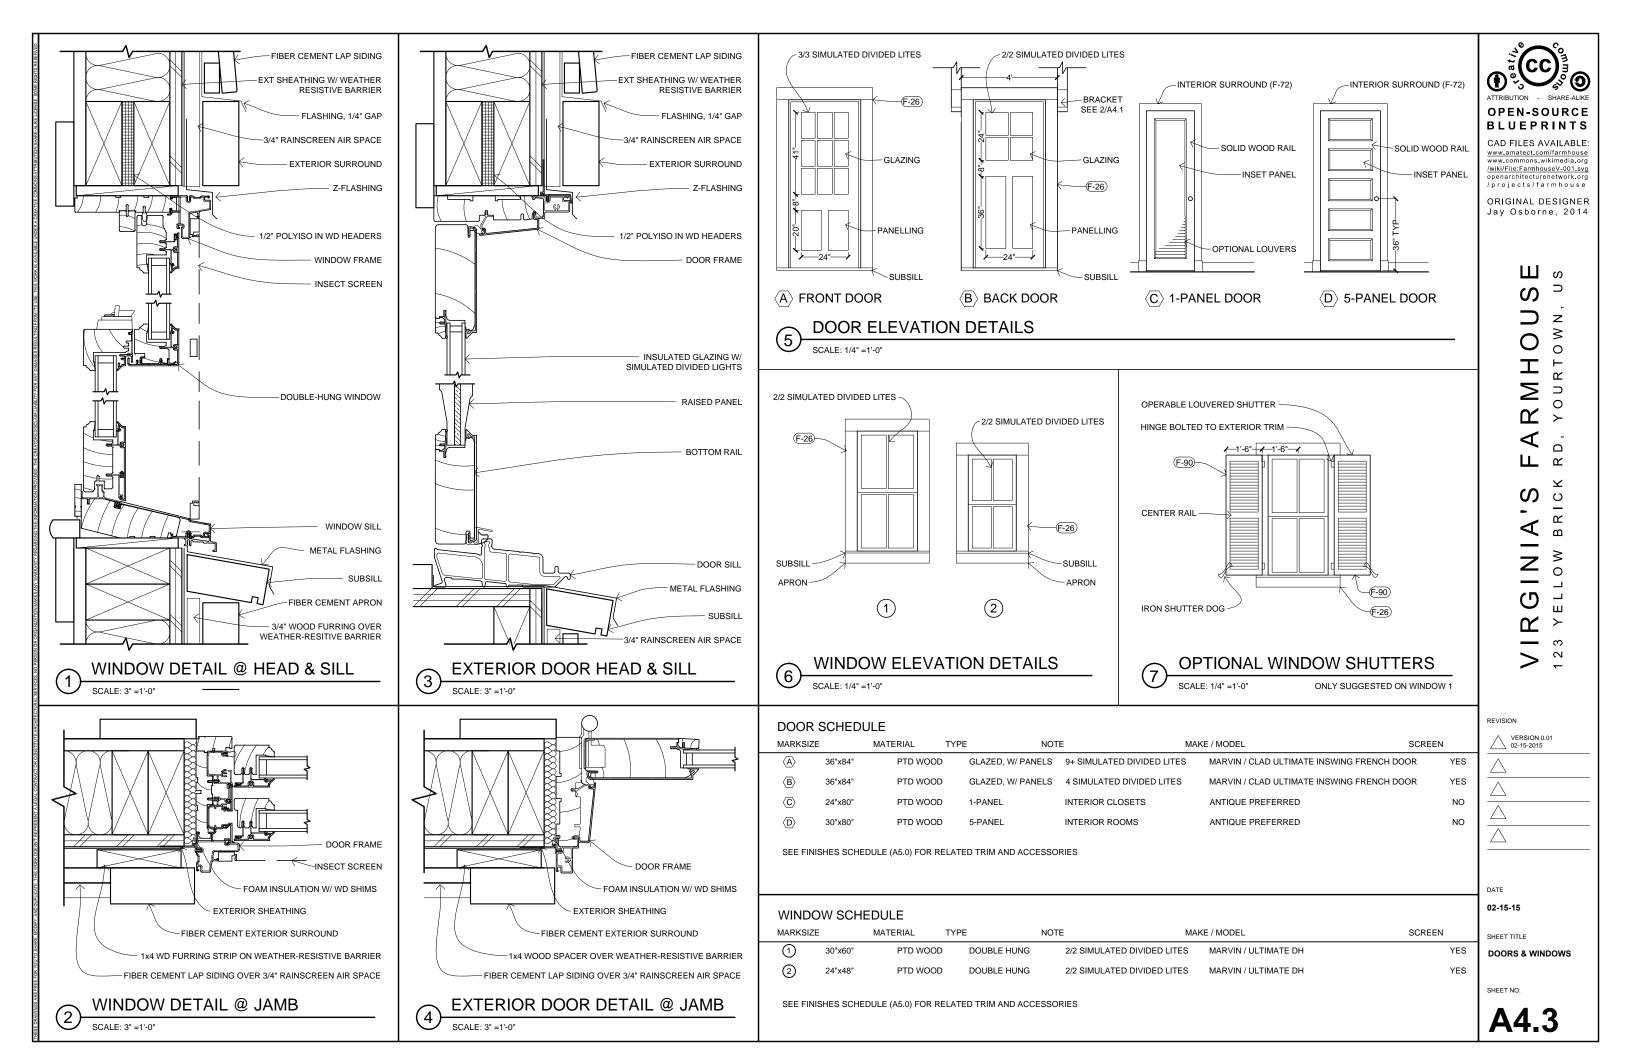

ROOM FINISHES SCHEDULE													
ROOM		FLOOR	CEILING		WALL		WAINSCOT		CROW	N	BASE		NOTES
STAIR HALL (UPPER)		HARDWOOD	BEADBOA	RD	GYP BD		-		YES		WOOD		-
STAIR HALL (LOWER)		HARDWOOD	GYP BD		GYP BD		-		-		WOOD		-
LIVING ROOM		HARDWOOD	GYP BD		GYP BD		YES		YES		WOOD		36" WAINSCOT
DINING / KITCHEN		HARDWOOD	BEADBOA	RD	GYP BD		YES		YES		WOOD		36" WAINSCOT
WATER CLOSET		TILE	GYP BD		GYP BD		YES		-		TILE COVI	≣	42" WAINSCOT
BATHROOM	TILE	G'	/P BD	GYF	BD	YES		-	Т	ΓILE	COVE	42" \	WAINSCOT
MAIN BEDROOM		HARDWOOD	GYP BD		GYP BD		-		-		WOOD		-
BEDROOM		HARDWOOD	GYP BD		GYP BD		-		-		WOOD		-
FRONT PORCH		WD PLANKS	BEADBOA	RD	-		-		YES		-		-

X-00		SIZE	NOTE	MAKE / MODEL PAG
	REFRIGERATOR	25x25x69"	ENERGY STAR	BLOMBERG / BRFB1042SS
X-02	KITCHEN SINK	24"x18"	SINGLE BOWL, VITREOUS CHINA	HIGHPOINT COLLECTION / FIRECLAY
X-04	RANGE / OVEN	24"x24"x36"	-	-
X-06	RANGE HOOD	24"x24"x6"	-	-
X-08	WATER FAUCET	4" CENTERSET	TUSCAN BRONZE	PRICE PFISTER / ASHFIELD T43-YP0Y
X-10	KITCHEN COUNTERTOP	2" THICK	WOOD SURFACE (TILE OPTIONAL)	IKEA / AKERBY
X-12	FLOOR CABINETS	12", 24" WIDE	STAT WHITE, BIRCH EFFECT	IKEA / AKURUM
K-14	WALL CABINETS	12" WIDE	GLAZED DOORS PREFERRED	IKEA / AKURUM
X-20	TOILET	26"x18"	1.0 GPF	TOTO / ROWAN CST405MF
X-22	WC TOILET	-	WALL HUNG, 1.6 GPF	AQUIA / WALL HUNG DUAL FLUSH TOILET CT418F
X-24	CORNER SINK	16"x16" MAX	VITREOUS CHINA	ELIZABETHAN CLASSICS / ETCB CORNER BASIN
X-26	BATHROOM LAVATORY	21"x42"	-	
X-28	BATHTUB	30"x60"x12"	-	KOHLER / STERLING 71091120
X-30	MIRROR CABINET	25"x38"x6"	WHITE, ADD TRIM MOLDINGS AROUND	IKEA / HEMNES
X-40	WOODSTOVE	14"x19"x22"	USE DOUBLE WALL CONNECTOR	JOTUL / F3 CB
X-42	CORNER CUPBOARD	~24"x24"x80"		ANTIQUE PREFERRED
X-44	WASHER / DRYER COMBO	24"x34"x23"	-	HAIER / HWD1600BW
X-46	CRAWLSPACE ACCESS	-	-	-
X-48	CHIMNEY CLEANOUT	8"x8"	-	-
X-50	ATTIC ACCESS DOOR	16"x32"	-	-
X-80	TANKLESS WATER HEATER	-		STIEBEL / ELTRON MINI
X-82	WALL-MOUNTED LIGHT	-	-	-
X-84	INTERIOR CEILING FAN	-		-
X-86	EXTERIOR CEILING FAN	-		-

MARKITEN	l SIZ	E N	NC NC	DTES S	EE:
F-00	BRICK	-	RECLAIMED BRICK	SMOOTH CREAMY TEXTURE, RED, CONCAVE MORTAR JOIN	Γ A4.0, A4.
F-02	WOOD FRAMING	VARIES	SOUTHERN WHITE PINE	STRUCTURAL GRADE	A3.0
F-04	FLOOR GIRDER	-	GLULAM	-	A3.0
F-06	SUBFLOOR	3/4"	PLYWOOD	OPTIONAL INTEGRATED RADIANT FLOOR SYSTEM	A4.0
F-08	EXT WALL SHEATHING	1/2"	PLYWOOD	OPTIONAL INSULATED SHEATHING	A4.0
F-10	BATT INSULATION	3-1/2"	FIBERGLASS	R-18	A4.0
F-12	RIGID INSULATION	1/2"	POLYISO	SANDWICH B/T EXTERIOR DOOR AND WINDOW HEADERS	A4.3
F-14)	RIGID INSULATION	1-1/2"	XPS	-	A4.0
F-16	BUILDING PAPER	15#	BITUMEN	WEATHER-RESISTIVE BARRIER	A4.0
F-18	FLASHING	-	COPPER	-	A4.1
F-20	FLOOR DECKING	1x4	CEDAR	OPT T&G, OPT FIBER CEMENT BOARDS	A4.2
F-22	PORCH COLUMN	6x6	WOOD	CHAMFERED 1" FROM EDGES	A4.2
F-24)	CLAPBOARD SIDING	6"	FIBER CEMENT	JAMES HARDIE / ARTISAN LAP SIDING	A4.0
F-26	EXT OPENING CASING	5-6"	FIBER CEMENT	3/4 HARDIPLANK	A4.3
F-28	BED MOLDING	-	PVC		A4.2
F-30	CYMA RECTA	-	PVC		A4.2
F-32	CROWN MOLDING	-	PVC		A4.2
F-34)	FRIEZE BOARD	5/4	FIBER CEMENT		A4.1
F-36	WATER TABLE	5/4	FIBER CEMENT		A4.2
-38	CORNER BOARD	4/4 (1")	FIBER CEMENT		A2.0
$\overline{}$					
F-40	5V METAL ROOF PANELS	24"OC	GALV STEEL	OPTIONAL: STANDING SEEM METAL ROOF PANELS @ 24"OC	A2.0
F-42)	BULBED RIDGE CAP	4"	GALV STEEL	-	A2.0
F-44)	HALF-ROUND GUTTER	5" DIA G	GALV STEEL OF	PTIONAL: COPPER A	2.0, A4.2
F-46)	FASCIA BOARD	1x6	FIBER CEMENT	-	A4.2
F-48)	SOFFIT PANEL	1/2"	FIBER CEMENT	-	A4.2
F-50	ATTIC VENT	-	-	-	A2.1, A2
F-52)	CHIMNEY CAP	-	PRECAST CONCRETE	OPTIONAL: SPARK ARRESTOR	A4.1
F-60	HARDWOOD FLOOR	2-3" WIDE	FINISH WOOD	-	-
F-62	FLOOR TILE	-	CERAMIC	HEXAGONAL PATTERN	-
F-64)	WALL TILE	4" SQUARE	CERAMIC	-	-
F-66	BRICK TILE	1/2" THICK	RECLAIMED BRICK	THIN BRICK VENEER OVER BACKER BOARD	-
F-68	BASE MOLDING	1x4	FINISH WOOD	INCLUDE DECORATIVE BASE CAP MOLDING	-
F-70	INTERIOR SHEATHING	1/2"	GYPSUM WALLBOARD	-	_
F-72)	INT OPENING CASING	1x4	WOOD	PAINTED	-
F-74)	BEADBOARD	1/2"	COMPOSITE PANEL	EXTERIOR GRADE BEADBOARD TO BE USED AT PORCH	-
F-76)	WAINSCOT CAP	-	WOOD	PAINTED	-
F-78)	HANDRAIL	2"	FINISH WOOD	-	-
F-80	NEWEL POST	4x4	WOOD	PAINTED	-
F-82	CROWN MOLDING	-	WOOD OR MDF	PAINTED	_
F-84)	CAVETTO	3/4"	FINISH WOOD	_	_
F-90)	WINDOW SHUTTERS	15"x60"	WOOD	- MUST BE OPERABLE, LOUVERED, W/ CENTER RAIL	A4.3
	THE CAN DIGITERS	13 800	***************************************	MOST DE OF ENABLE, LOUVENED, W/ CENTER RAIL	A4.3



CAD FILES AVAILABLE: www.amatect.com/farmhouse www.commons.wikimedia.org /wiki/File:FarmhouseV-001.svg openarchitecturenetwork.org /projects/farmhouse

ORIGINAL DESIGNER Jay Osborne, 2014

VIRGINIA'S FARMHOUSE

EVISION								
Λ	VERSION (

\triangle	VERSION 0.01 02-15-2015
\triangle	
\triangle	
\triangle	

DATE

02-15-15

SHEET TITLE
SCHEDULES

SHEET NO.

A5.0